ABBREVIATIONS THIRD PARTY LOGISTICS AIR CONDITIONING ACOUSTICAL CEILING TILE ADJ ADJUSTABLE ABOVE FINISHED FLOOR AMP AMPERE ARCH ARCHITECT BOH BACK OF HOUSE CABINET CENTER LINE CEILING CM CONSTRUCTION MANAGER CTR CENTER CX COMMISSIONING COMMISSIONING AGENT DEG DEGREE DET DETAIL DIA DIAMETER DIMENSION DM DESIGN MANAGER DN EACH **ELEVATION** EQUAL EXIST EXISTING EXT EXTERIOR "FURNITURE, FIXTURE, AND EQUIPMENT" FURNISHED AND INSTALLED BY OWNER FLR FLOOR FRONT OF HOUSE FT FOOT/FEET GROUND GENERAL CONTRACTOR HC HOLLOW CORE HDW HARDWARE HOLLOW METAL HORIZ HORIZONTAL HR HOUR HEIGHT HVAC "HEATING, VENTILATING, AND AIR CONDITIONING" INSIDE DIAMETER LANDLORD MAXIMUM "MECHANICAL, ELECTRICAL, AND PLUMBING" MANUFACTURER MIN MINIMUM NOT IN CONTRACT NIGHT LIGHT NTS NOT TO SCALE OC ON CENTER OUTSIDE DIAMETER OF/CI OWNER FURNISHED/CONTRACTOR INSTALLED OF/OI OWNER FURNISHED/OWNER INSTALLED PRODUCTION DESIGNER PLACE PROJECT MANAGER RADIUS RENOVATIONS CONSTRUCTION MANAGER REF REFERENCE REQ'D REQUIRED REV REVISION RND ROUND

STARBUCKS

SOLID CORE

SHEET SIMILAR

SPEC SPECIFICATION

TEMP TEMPORARY TYP TYPICAL

VERT VERTICAL VIF VERIFY IN FIELD

SQ SQUARE

SHT

SIM

SQUARE FEET

UON UNLESS OTHERWISE NOTED

VENDOR DIRECT

COUNTY, STATE, AND FEDERAL CODES AND ORDINANCES. ARCHITECTURAL SYMBOL LEGEND

GENERAL NOTES

1. GENERAL CONTRACTOR SHALL VISIT THE SITE, REVIEW THE BUILDING SHELL DRAWINGS AS SUBMITTED BY THE LANDLORD OR STARBUCKS SITE SURVEYOR, AND BECOME THOROUGHLY FAMILIAR WITH THE SITE CONDITIONS PRIOR TO BIDDING OR CONSTRUCTION.

2. GENERAL CONTRACTOR SHALL CONSULT WITH STARBUCKS CONSTRUCTION MANAGER TO RESOLVE ANY CHANGES, OMISSIONS, OR PLAN DISCREPANCIES PRIOR TO BIDDING OR CONSTRUCTION.

3. ALL WORK SHALL BE PERFORMED IN STRICT COMPLIANCE WITH LOCAL,

4. GENERAL CONTRACTOR SHALL VERIFY THE LOCATION OF ALL UTILITIES.

5. GENERAL CONTRACTOR TO VERIFY ALL DIMENSIONS, INCLUDING CLEARANCES REQUIRED BY OTHER TRADES, AND NOTIFY STARBUCKS CONSTRUCTION MANAGER OF ANY DISCREPANCIES PRIOR TO PROCEEDING WITH THE WORK. ALL DIMENSIONS ARE TO THE FACE OF THE FINISHED SURFACE UNLESS NOTED OTHERWISE. ALL DIMENSIONS TO BE TAKEN FROM DESIGNATED DATUM POINT. DO NOT SCALE DRAWINGS.

6. GENERAL CONTRACTOR SHALL PATCH AND REPAIR ALL EXISTING WALLS, FLOORS, CEILINGS, OR OTHER SURFACES IDENTIFIED TO REMAIN THAT MAY BECOME DAMAGED DURING THE COURSE OF THE WORK.

7. THE GENERAL CONTRACTOR IS RESPONSIBLE FOR OBTAINING PERMITS FOR FIRE PROTECTION, PLUMBING, MECHANICAL, AND ELECTRICAL SYSTEMS PRIOR TO INSTALLATION OF SUCH SYSTEMS.

8. GENERAL CONTRACTOR SHALL RETAIN ONE SET OF THE PLANS TO NOTE AND DOCUMENT ALL CHANGES DURING CONSTRUCTION. THIS SET SHALL BE A PART OF THE GENERAL CONTRACTOR'S "STORE CLOSE-OUT PACKAGE" AS DESCRIBED IN THE CONSTRUCTION MANAGEMENT AGREEMENT.

9. GENERAL CONTRACTOR IS RESPONSIBLE FOR COORDINATING DELIVERY OF MATERIALS FROM STARBUCKS CONTRACTED THIRD PARTY LOGISTICS DISTRIBUTION SERVICES AND VENDOR DIRECT SHIPMENTS. REFER TO CONSTRUCTION MANAGEMENT AGREEMENT FOR METHODS AND LEAD TIMES.

10. RESPONSIBILITY FOR SUPPLY AND DELIVERY OF MATERIALS AND EQUIPMENT IS IDENTIFIED IN THE DRAWING SCHEDULE SHEETS UNDER THE COLUMN LABELED "RESPONSIBILITY".

11. FOR THE PURPOSE OF THE DOCUMENTS, TO "INSTALL", SHALL MEAN TO PROVIDE ALL FASTENERS, MISCELLANEOUS HARDWARE, BLOCKING, ELECTRICAL CONNECTIONS, PLUMBING CONNECTIONS, AND OTHER ITEMS REQUIRED FOR A COMPLETE AND OPERATION INSTALLATION, UNLESS

PXXX-ES PAINT TAG

X XXXXX DESIGN ID TAG

X XXXXX DESIGN ID TAG

DXXXXX DOOR TAG

(WXXXXX) WINDOW TAG

X'-XX" AFF ABOVE FINISHED FLOOR

XXXX AFF ABOVE FINISHED FLOOR

HEIGHT TAG (IMPERIAL)

HEIGHT TAG (METRIC)

DIMENSION LINE FROM

REVISION CLOUD

FINISH FACE TO FINISH

12. ALL ITEM SUBSTITUTIONS MUST BE APPROVED BY THE STARBUCKS DESIGN MANAGER.

13. REFER TO ITEM CUTSHEETS FOR ADDITIONAL INFORMATION.

NORTH ARROW

EXTERIOR ELEVATION

INTERIOR ELEVATION

SECTION CALLOUT

DETAIL CALLOUT

REVISION TAG

DATUM POINT

DEFERRED SUBMITTALS

INCLUDED UNDER THE SCOPE OF THIS SUBMITTAL.

REVISIONS TO FIRE SPRINKLER SYSTEM FOR TENANT IMPROVEMENT.

FIRE SPRINKLER PERMIT MUST BE OBTAINED PRIOR TO FRAMING INSPECTION.

BUILDING AND SITE SIGNAGE SHOWN FOR REFERENCE ONLY AND ARE NOT

TENANT IMPROVEMENTS WHICH PROMULGATE MODIFICATIONS TO THE FIRE

SPRINKLER OR FIRE ALARM SYSTEM SHALL BE SUBMITTED TO THE FIRE

DEPARTMENT UNDER SEPARATE PERMIT PRIOR TO INSTALLATION.

PROVIDE PROOF OF 5 YEAR FIRE SPRINKLER MAINTENANCE AND

PROJECT CONTACTS

MAILING ADDRESS: STARBUCKS COFFEE COMPANY 2401 UTAH AVENUE SOUTH MS STOP: S-SD10 SEATTLE, WASHINGTON 98134 (206) 318-1575

DESIGN MANAGER: ANDREW HUMAYDAN STARBUCKS COFFEE COMPANY **60 SPEAR STREET** SEVENTH FLOOR SAN FRANCISCO, CA 94105

(415) 241-0256 PHONE

CONSTRUCTION TERRIE TATE

MANAGER:

STARBUCKS COFFEE COMPANY 60 SPEAR STREET SEVENTH FLOOR

SAN FRANCISCO, CA 94105 (415) 241-0256 PHONE

LANDLORD: DON IMWALLE **IMWALLE PROPERTIES** 115 SOUTH MARKET ST SUITE 190

(408) 287-3838 PHONE

(408) 283-5210 FAX

ARCHITECT OF RECORD: SALAS O'BRIEN 305 11TH STREET

SAN JOSE, CA 95112 (408) 621-5714 PHONE (408) 297-2995 FAX

(408) 522-5260 FAX

ACIES ENGINEERING MEP CONSULTANT OF 111 W. EVELYN AVE RECORD: SUITE 301 SUNNYVALE, CA 94086 (408) 522-5255 PHONE

PROJECT DESCRIPTION

INITIAL TENANT IMPROVEMENT OF A STARBUCKS CAFE INCLUDING MECHANICAL, PLUMBING AND ELECTRICAL IMPROVEMENTS.

LEGAL DESCRIPTION

PARCEL NUMBER: 296-40-007

CODE NOTES

ZONING: C1 - NEIGHBORHOOD COMMERCIAL

OCCUPANCY: A-2 USE: CAFE

TYPE OF CONSTRUCTION: V-B SPRINKLERS: YES

> PROPERTY SIZE: 30,259 SF BUILDING AREA: 7,772 SF

TENANT AREA: 1600 SF BUILDING HEIGHT: 1 STORY


OCCUPANT LOAD: BAR 266 SF / 200 = 2 WORKROOM 262 SF / 200 = 2 SALES 298 SF / 30 = 10 537 SF / 15 = 36 CAFE SEATING TOTAL OCCUPANT LOAD

APPLICABLE CODES: 2013 CALIFORNIA BUILDING CODE* 2013 CALIFORNIA FIRE CODE*

> 2010 CALIFORNIA ENERGY CODE** 2013 CALIFORNIA PLUMBING CODE* 2013 CALIFORNIA MECHANICAL CODE 3 2013 CALIFORNIA ELECTRICAL CODE*

2013 CALIFORNIA GREEN BUILDING CODE* * = WITH CITY OF SAN JOSE AMENDMENTS ** = 2013 ENERGY CODE ADOPTED JULY 2014

VICINITY PLAN

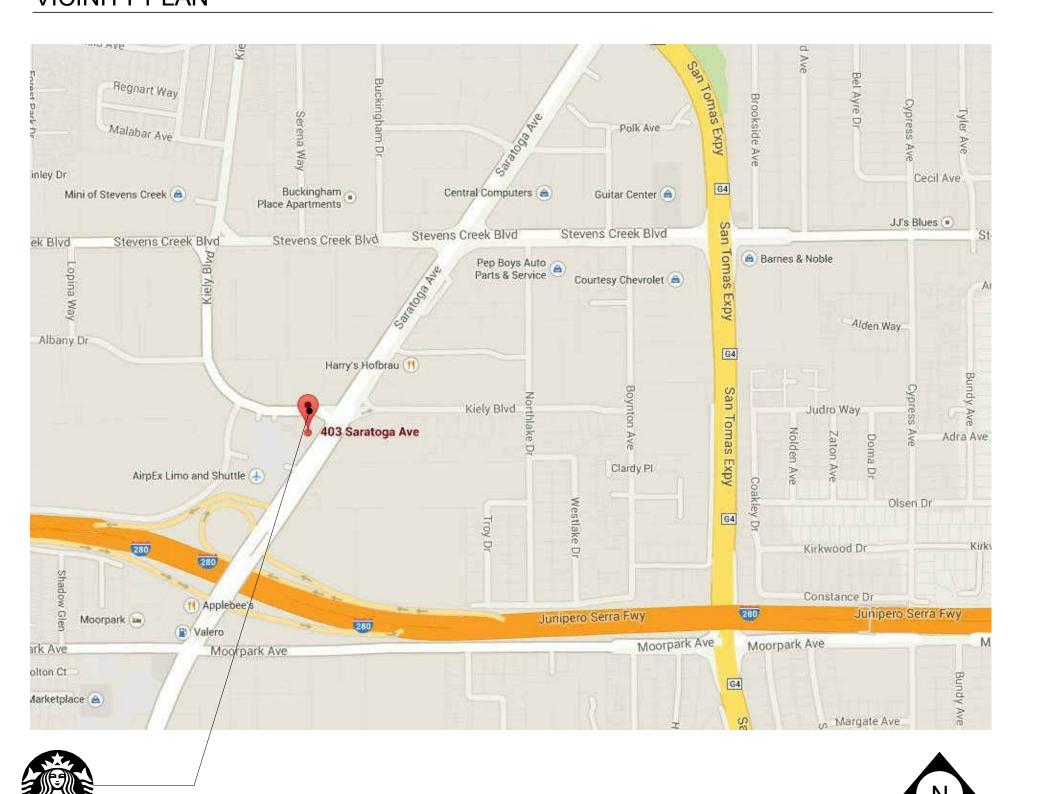

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G-0011	DESIGN SPECIFICATIONS	I-5013	CASEWORK DETAILS
G-0012	DESIGN SPECIFICATIONS	I-6001	SCHEDULES
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A-5001	ARCHITECTURAL SITE DETAILS	DULIMBINI	
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I-110 4 I-1105	FE AND F PLAN	P-1101 P-1102	PLUMBING DESIGN PLUMBING WASTE PLAN
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I-2101	INTERIOR ELEVATIONS	E-1102	ELECTRICAL DESIGN
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I-4102	ENLARGED RESTROOM PLAN AND ELEVATIONS	E-1104	ELECTRICAL ROOF DESIGN
I-5001	DESIGN DETAILS	E-5001	ELECTRICAL DETAILS
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I-5003	DESIGN DETAILS	E-6002	ENERGY CODE CALCULATIONS
	-	E-6003	ENERGY CALCULATIONS



Starbucks Coffee 2401 Utah Avenue South

Seattle, Washington 98134 (206) 318-1575


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Architect of Record SALASOBRIEN





OUNTY:

Store #: 20170 Project # 55066-003 MCS Issue Date: 4/10/14

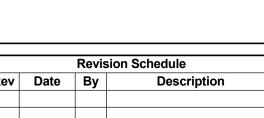ANDREW

HUMAYDAN

A. HUMAYDEN

Design Manager: LEED® AP:

S

Production Designer:

Checked by:

Sheet Title:

Concept:

Palette:

GENERAI INFORMATION As indicated

Sheet Number:

GENERAL CONDITIONS SECTION 014200 - REFERENCES PART 1 - GENERAL 1.1 INDUSTRY STANDARDS APPLICABILITY OF STANDARDS: UNLESS THE CONTRACT DOCUMENTS INCLUDE MORE STRINGENT REQUIREMENTS, APPLICABLE CONSTRUCTION INDUSTRY STANDARDS HAVE THE SAME FORCE AND EFFECT AS IF BOUND OR COPIED DIRECTLY INTO THE CONTRACT DOCUMENTS TO THE EXTENT REFERENCED. SUCH STANDARDS ARE MADE A PART OF THE CONTRACT DOCUMENTS BY REFERENCE. PUBLICATION DATES: COMPLY WITH STANDARDS IN EFFECT AS OF DATE OF THE CONTRACT DOCUMENTS UNLESS OTHERWISE INDICATED. COPIES OF STANDARDS: EACH ENTITY ENGAGED IN CONSTRUCTION ON PROJECT SHOULD BE FAMILIAR WITH INDUSTRY STANDARDS APPLICABLE TO ITS CONSTRUCTION ACTIVITY. COPIES OF APPLICABLE STANDARDS ARE NOT BOUND WITH THE CONTRACT DOCUMENTS. WHERE COPIES OF STANDARDS ARE NEEDED TO PERFORM A REQUIRED CONSTRUCTION ACTIVITY, OBTAIN COPIES DIRECTLY FROM PUBLICATION SOURCE. ABBREVIATIONS AND ACRONYMS INDUSTRY ORGANIZATIONS: WHERE ABBREVIATIONS AND ACRONYMS ARE USED IN SPECIFICATIONS OR OTHER CONTRACT DOCUMENTS, THEY SHALL MEAN THE RECOGNIZED NAME OF THE ENTITIES IN THE FOLLOWING LIST. AMERICAN CONCRETE INSTITUTE AHA AMERICAN HARDBOARD ASSOCIATION AITC AMERICAN INSTITUTE OF TIMBER CONSTRUCTION ANSI AMERICAN NATIONAL STANDARDS INSTITUTE APA APA - THE ENGINEERED WOOD ASSOCIATION AMERICAN SOCIETY OF HEATING, REFRIGERATING AND ASHRAE **AIR-CONDITIONING ENGINEERS** ASTM ASTM INTERNATIONAL (AMERICAN SOCIETY FOR TESTING AND MATERIALS INTERNATIONAL) AWI ARCHITECTURAL WOODWORK INSTITUTE AWPA AMERICAN WOOD PROTECTION ASSOCIATION (FORMERLY: AMERICAN WOOD PRESERVERS' ASSOCIATION) CRI CARPET AND RUG INSTITUTE (THE) COOL ROOF RATING COUNCIL CRRC CANADIAN STANDARDS ASSOCIATION CSA CSA INTERNATIONAL (FORMERLY: IAS - INTERNATIONAL APPROVAL SERVICES) CONSTRUCTION SPECIFICATIONS INSTITUTE (THE) CSI ETL SEMCO INTERTEK ETL SEMCO FORMERLY: ITS - INTERTEK TESTING SERVICE NA) FM GLOBAL FM GLOBAL (FORMERLY: FMG - FM GLOBAL) FSC FOREST STEWARDSHIP COUNCÍL HARDWOOD PLYWOOD & VENEER ASSOCIATION HPVA ISO INTERNATIONAL ORGANIZATION FOR STANDARDIZATION ITS INTERTEK TESTING SERVICE NA (NOW ETL SEMCO) MFMA MAPLE FLOORING MANUFACTURERS ASSOCIATION, INC. MASTER PAINTERS INSTITUTE NFPA (NATIONAL FIRE PROTECTION ASSOCIATION) NOFMA NOFMA: THE WOOD FLOORING MANUFACTURERS ASSOCIATION (FORMERLY: NATIONAL OAK FLOORING MANUFACTURERS ASSOCIATION) OPL STEEL DOOR INSTITUTE SHEET METAL AND AIR CONDITIONING CONTRACTORS' **SMACNA** NATIONAL ASSOCIATION UL UNDERWRITERS LABORATORIES INC. USGBC U.S. GREEN BUILDING COUNCIL WEST COAST LUMBER INSPECTION BUREAU WCLIB WOODWORK INSTITUTE (FORMERLY: WIC - WOODWORK INSTITUTE OF CALIFORNIA) CODE AGENCIES: WHERE ABBREVIATIONS AND ACRONYMS ARE USED IN SPECIFICATIONS OR OTHER CONTRACT DOCUMENTS, THEY SHALL MEAN THE RECOGNIZED NAME OF THE ENTITIES IN THE FOLLOWING LIST. DEUTSCHES INSTITUT FUR NORMUNG E.V. INTERNATIONAL CODE COUNCIL ICC EVALUATION SERVICE, INC. ICC-ES FEDERAL GOVERNMENT AGENCIES: WHERE ABBREVIATIONS AND ACRONYMS ARE USED IN SPECIFICATIONS OR OTHER CONTRACT DOCUMENTS, THEY SHALL MEAN THE RECOGNIZED NAME OF THE ENTITIES IN THE FOLLOWING LIST. **ENVIRONMENTAL PROTECTION AGENCY** STANDARDS AND REGULATIONS: WHERE ABBREVIATIONS AND ACRONYMS ARE USED IN SPECIFICATIONS OR OTHER CONTRACT DOCUMENTS, THEY SHALL MEAN THE RECOGNIZED NAME OF THE STANDARDS AND REGULATIONS IN THE FOLLOWING LIST. AMERICANS WITH DISABILITIES ACT (ADA) ARCHITECTURAL BARRIERS ACT (ABA) ACCESSIBILITY GUIDELINES FOR BUILDINGS AND FACILITIES AVAILABLE FROM U.S. ACCESS BOARD CODE OF FEDERAL REGULATIONS AVAILABLE FROM GOVERNMENT PRINTING OFFICE STATE GOVERNMENT AGENCIES: WHERE ABBREVIATIONS AND ACRONYMS ARE USED IN SPECIFICATIONS OR OTHER CONTRACT DOCUMENTS. THEY SHALL MEAN THE RECOGNIZED NAME OF THE ENTITIES IN THE FOLLOWING

CALIFORNIA DEPARTMENT OF HEALTH SERVICES

SECTION

END OF SECTION 014200

CALIFORNIA DEPARTMENT OF PUBLIC HEALTH, INDOOR AIR QUALITY

GENERAL CONDITIONS (CONTINUED)

SECTION 017419 - CONSTRUCTION WASTE MANAGEMENT AND DISPOSAL

A. SALVAGING NONHAZARDOUS DEMOLITION AND CONSTRUCTION WASTE.
B. RECYCLING NONHAZARDOUS DEMOLITION AND CONSTRUCTION WASTE.
C. DISPOSING OF NONHAZARDOUS DEMOLITION AND CONSTRUCTION WASTE.

DEFINITIONS

A. CONSTRUCTION WASTE: BUILDING AND SITE IMPROVEMENT MATERIALS
AND OTHER SOLID WASTE RESULTING FROM CONSTRUCTION, REMODELING,
RENOVATION, OR REPAIR OPERATIONS. CONSTRUCTION WASTE INCLUDES

RENOVATION, OR REPAIR OPERATIONS. CONSTRUCTION WASTE INCLUDE PACKAGING.

B. DEMOLITION WASTE: BUILDING AND SITE IMPROVEMENT MATERIALS RESULTING FROM DEMOLITION OR SELECTIVE DEMOLITION OPERATIONS.

C. DISPOSAL: REMOVAL OFF-SITE OF DEMOLITION AND CONSTRUCTION

SUBSEQUENT PROCESSING IN PREPARATION FOR REUSE.

WASTE AND SUBSEQUENT SALE, RECYCLING, REUSE, OR DEPOSIT IN LANDFILL OR INCINERATOR ACCEPTABLE TO AUTHORITIES HAVING JURISDICTION.

D. RECYCLE: RECOVERY OF DEMOLITION OR CONSTRUCTION WASTE FOR

E. SALVAGE: RECOVERY OF DEMOLITION OR CONSTRUCTION WASTE AND SUBSEQUENT SALE OR REUSE IN ANOTHER FACILITY.
 F. SALVAGE AND REUSE: RECOVERY OF DEMOLITION OR CONSTRUCTION WASTE AND SUBSEQUENT INCORPORATION INTO THE WORK.

1.3 PERFORMANCE REQUIREMENTS
A. END-OF-PROJECT RATES FOR SALVAGE/RECYCLING: [50] [75] PERCENT.

1.4 ACTION SUBMITTALS

A. WASTE MANAGEMENT PLAN: SUBMIT PLAN WITHIN 7 DAYS OF DATE ESTABLISHED FOR COMMENCEMENT OF THE WORK.
 1. TYPES AND QUANTITIES OF DEMOLITION AND CONSTRUCTION

 TYPES AND QUANTITIES OF DEMOLITION AND CONSTRUCTION WASTE.
 TYPE OF WASTE AND WHETHER IT WILL BE SALVAGED, RECYCLED,

OR DISPOSED OF IN LANDFILL OR INCINERATOR.

3. NET ADDITIONAL COST OR NET SAVINGS RESULTING FROM WASTE MANAGEMENT PLAN

1.5 INFORMATION SUBMITTALS
A. WASTE REDUCTION PROGRESS REPORTS: CONCURRENT WITH EACH
APPLICATION FOR PAYMENT, SUBMIT REPORT INDICATING TYPE OF WASTE
AND WHETHER IT HAS BEEN SALVAGED, RECYCLED, OR DISPOSED OF IN
LANDFILL OR INCINERATOR.

B. WASTE DISPOSAL RECORDS: INDICATE RECEIPT AND ACCEPTANCE OF WASTE MATERIAL BY ACCEPTING AND PROCESSING FACILITIES LICENSED TO ACCEPT THEM. INCLUDE MANIFESTS, TYPE OF MATERIAL, WEIGHT OR VOLUME TICKETS, RECEIPTS, AND INVOICES.

C. LEED SUBMITTAL: CWM REPORTING TEMPLATE, TABULATING TOTAL
WASTE MATERIAL, QUANTITIES DIVERTED AND MEANS BY WHICH IT IS
DIVERTED, AND STATEMENT THAT REQUIREMENTS FOR THE CREDIT HAVE
BEEN MET.
RECYCLING WASTE

A. RECYCLING INCENTIVES: REVENUES AND OTHER INCENTIVES FOR RECYCLING WILL ACCRUE TO OWNER.

END OF SECTION 017419

GENERAL CONDITIONS (CONTINUED)

SECTION 018100 - SUSTAINABLE DESIGN REQUIREMENTS 1.1 SUMMARY

A. THIS SECTION INCLUDES GENERAL REQUIREMENTS AND PROCEDURES FOR COMPLIANCE WITH CERTAIN U.S. GREEN BUILDING COUNCIL'S (USGBC) LEED PREREQUISITES AND CREDITS NEEDED FOR THE PROJECT TO OBTAIN LEED CERTIFICATION BASED ON [LEED 2009 FOR RETAIL: COMMERCIAL INTERIORS] [LEED 2009 FOR RETAIL: NEW CONSTRUCTION].

1. OTHER LEED PREREQUISITES AND CREDITS NEEDED TO OBTAIN LEED CERTIFICATION ARE DEPENDENT ON MATERIAL SELECTIONS AND MAY NOT BE SPECIFICALLY IDENTIFIED AS LEED.

AND MAY NOT BE SPECIFICALLY IDENTIFIED AS LEED
REQUIREMENTS. COMPLIANCE WITH REQUIREMENTS NEEDED TO
OBTAIN LEED PREREQUISITES AND CREDITS MAY BE USED AS ONE
CRITERION TO EVALUATE SUBSTITUTION REQUESTS.

2. ADDITIONAL LEED PREREQUISITES AND CREDITS NEEDED TO OBTAIN THE INDICATED LEED CERTIFICATION ARE DEPENDENT ON THE ARCHITECT'S DESIGN AND OTHER ASPECTS OF THE PROJECT THAT ARE NOT PART OF THE WORK OF THE CONTRACT.

1.2 DEFINITIONS

A. BASE BUILDING MATERIAL: MATERIALS PERMANENTLY ATTACHED TO THE STRUCTURE. INCLUDES FINISHES AND PERMANENT CABINETS AND

B. CHAIN-OF-CUSTODY CERTIFICATES: CERTIFICATES SIGNED BY MANUFACTURERS CERTIFYING THAT WOOD USED TO MAKE PRODUCTS WAS OBTAINED FROM FORESTS CERTIFIED BY AN FSC-ACCREDITED CERTIFICATION BODY TO COMPLY WITH FSC STD-01-001, "FSC PRINCIPLES AND CRITERIA FOR FOREST STEWARDSHIP." CERTIFICATES SHALL INCLUDE EVIDENCE THAT MANUFACTURER IS CERTIFIED FOR CHAIN OF CUSTODY BY AN FSC-ACCREDITED CERTIFICATION BODY.

C. REGIONALLY MANUFACTURED MATERIALS: MATERIALS THAT ARE MANUFACTURED WITHIN A RADIUS OF 500 MILES (800 KM) FROM PROJECT SITE. MANUFACTURING REFERS TO THE FINAL ASSEMBLY OF COMPONENTS INTO THE BUILDING PRODUCT THAT IS INSTALLED AT PROJECT SITE

D. REGIONALLY EXTRACTED AND MANUFACTURED MATERIALS: REGIONALLY MANUFACTURED MATERIALS MADE FROM RAW MATERIALS THAT ARE EXTRACTED, HARVESTED, OR RECOVERED WITHIN A RADIUS OF 500 MILES (800 KM) FROM PROJECT SITE.

(800 KM) FROM PROJECT SITE.

RECYCLED CONTENT: MATERIAL THAT HAS BEEN BROKEN DOWN AND RECONSTITUTED INTO NEW MATERIAL. THE RECYCLED CONTENT VALUE OF A MATERIAL ASSEMBLY SHALL BE DETERMINED BY WEIGHT. THE RECYCLED FRACTION OF THE ASSEMBLY IS THEN MULTIPLIED BY THE COST OF ASSEMBLY TO DETERMINE THE RECYCLED CONTENT VALUE.

1. "POST-CONSUMER" MATERIAL IS DEFINED AS WASTE MATERIAL GENERATED BY HOUSEHOLDS OR BY COMMERCIAL, INDUSTRIAL, AND INSTITUTIONAL FACILITIES IN THEIR ROLE AS END USERS OF THE PRODUCT, WHICH CAN NO LONGER BE USED FOR ITS

2. "PRE-CONSUMER" MATERIAL IS DEFINED AS MATERIAL DIVERTED FROM THE WASTE STREAM DURING THE MANUFACTURING PROCESS. EXCLUDED IS REUTILIZATION OF MATERIALS SUCH AS REWORK, REGRIND, OR SCRAP GENERATED IN A PROCESS AND CAPABLE OF BEING RECLAIMED WITHIN THE SAME PROCESS THAT GENERATED IT.

F. RESOURCE REUSE: MATERIAL THAT HAS BEEN KEPT INTACT AND REPURPOSED TO A NEW USE ON THE SAME PROJECT SITE OR FOR THE ORIGINAL OR NEW USE ON A DIFFERENT PROJECT SITE. FURNITURE MAY BE REPURPOSED FOR THE ORIGINAL USE ON THE SAME PROJECT SITE.

A. GENERAL: SUBMIT ADDITIONAL LEED SUBMITTALS REQUIRED BY OTHER SPECIFICATION SECTIONS.

B. LEED DOCUMENTATION SUBMITTALS:

INTENDED PURPOSE.

CREDIT MR 2: COMPLY WITH SECTION 017419 "CONSTRUCTION WASTE MANAGEMENT AND DISPOSAL."
 CREDIT MR 3: RECEIPTS FOR SALVAGED AND REFURBISHED MATERIALS USED FOR PROJECT, INDICATING SOURCES AND

COSTS FOR SALVAGED AND REFURBISHED MATERIALS.

3. CREDIT MR 4: PRODUCT DATA AND CERTIFICATION LETTER FROM PRODUCT MANUFACTURERS INDICATING PERCENTAGES BY WEIGHT OF POST-CONSUMER AND PRE-CONSUMER RECYCLED CONTENT FOR PRODUCTS HAVING RECYCLED CONTENT. INCLUDE STATEMENT INDICATING MATERIAL COSTS FOR EACH PRODUCT.

CONTENT FOR PRODUCTS HAVING RECYCLED CONTENT. INCLUD STATEMENT INDICATING MATERIAL COSTS FOR EACH PRODUCT HAVING RECYCLED CONTENT.

4. CREDIT MR 5: PRODUCT DATA INDICATING LOCATION OF MATERIAL MANUFACTURER FOR REGIONALLY MANUFACTURED MATERIALS. INCLUDE STATEMENT INDICATING COST FOR EACH REGIONALLY MANUFACTURED MATERIAL AND FOR EACH

IONALLY EXTRACTED AND MANUFACTURED MATERIAL.

a. INCLUDE STATEMENT INDICATING DISTANCE FROM
MANUFACTURER TO PROJECT FOR EACH REGIONALLY
MANUFACTURED MATERIAL.

b. INCLUDE STATEMENT INDICATING LOCATION OF AND DISTANCE FROM PROJECT TO POINT OF EXTRACTION, HARVEST, OR RECOVERY FOR EACH RAW MATERIAL USED IN REGIONALLY EXTRACTED AND MANUFACTURED MATERIALS.

5. CREDIT MR 7: PRODUCT DATA AND CHAIN-OF-CUSTODY CERTIFICATES FOR PRODUCTS CONTAINING CERTIFIED WOOD. INCLUDE STATEMENT INDICATING COST FOR EACH CERTIFIED WOOD PRODUCT.

6. CREDIT IEQ 3.1:
a. CONSTRUCTION INDOOR-AIR-QUALITY MANAGEMENT PLAN.

a. CONSTRUCTION INDOOR-AIR-QUALITY MANAGEMENT PLAN
b. PRODUCT DATA FOR TEMPORARY FILTRATION MEDIA.
c. PRODUCT DATA FOR FILTRATION MEDIA USED DURING

OCCUPANCY.
d. CONSTRUCTION DOCUMENTATION: SIX PHOTOGRAPHS AT THREE DIFFERENT TIMES DURING THE CONSTRUCTION PERIOD, ALONG WITH A BRIEF DESCRIPTION OF THE SMACNA APPROACH EMPLOYED, DOCUMENTING IMPLEMENTATION OF THE INDOOR-AIR-QUALITY MANAGEMENT MEASURES, SUCH AS PROTECTION OF

MATERIALS.
7. CREDIT IEQ 3.2:

CREDIT IEQ 3.2:

a. SIGNED STATEMENT DESCRIBING THE BUILDING AIR FLUSHOUT PROCEDURES INCLUDING THE DATES WHEN FLUSHOUT WAS BEGUN AND COMPLETED AND STATEMENT THAT
FILTRATION MEDIA WAS REPLACED AFTER FLUSH-OUT.

INSIDE THE WEATHERPROOFING SYSTEM INDICATING VOC CONTENT

DUCTS AND ON-SITE STORED OR INSTALLED ABSORPTIVE

 b. PRODUCT DATA FOR FILTRATION MEDIA USED DURING FLUSH-OUT AND DURING OCCUPANCY.
 8. CREDIT IEQ 4A: PRODUCT DATA FOR ADHESIVES AND SEALANTS

8. CREDIT IEQ 4A: PRODUCT DATA FOR ADHESIVES AND SEALANTS
USED INSIDE THE WEATHERPROOFING SYSTEM INDICATING VOC
CONTENT OF EACH PRODUCT USED.

9. CREDIT IEQ 4B: PRODUCT DATA FOR PAINTS AND COATINGS USED

OF EACH PRODUCT USED.

10. CREDIT IEQ 4D: PRODUCT DATA FOR PRODUCTS CONTAINING
COMPOSITE WOOD OR AGRIFIBER PRODUCTS OR WOOD GLUES
INDICATING THAT THEY DO NOT CONTAIN UREA-FORMALDEHYDE

SECTION 017419 "CONSTRUCTION WASTE MANAGEMENT AND

INFORMATIONAL SUBMITTALS

A. LEED ACTION PLANS: PROVIDE PRELIMINARY SUBMITTALS WITHIN SEVEN
DAYS OF DATE ESTABLISHED FOR COMMENCEMENT OF THE WORK
INDICATING HOW THE FOLLOWING REQUIREMENTS WILL BE MET:

1. CREDIT MR 2: WASTE MANAGEMENT PLAN COMPLYING WITH

DISPOSAL."

2. CREDIT IEQ 3.1: CONSTRUCTION INDOOR-AIR-QUALITY

MANAGEMENT PLAN.

B. LEED PROGRESS REPORTS: CONCURRENT WITH EACH APPLICATION FOR PAYMENT, SUBMIT REPORTS COMPARING ACTUAL CONSTRUCTION AND PURCHASING ACTIVITIES WITH LEED ACTION PLANS FOR THE FOLLOWING:

1. CREDIT MR 2: WASTE REDUCTION PROGRESS REPORTS COMPLYING WITH SECTION 017419 "CONSTRUCTION WASTE MANAGEMENT AND

DISPOSAL."
END OF SECTION 018100

GENERAL CONDITIONS (CONTINUED)

SECTION 019113 - GENERAL COMMISSIONING REQUIREMENTS

1.1 SUMMARY
A. COMMISSIONING TEAM:

1. MEMBERS REPRESENTING CONTRACTOR, INCLUDING PROJECT SUPERINTENDENT AND SUBCONTRACTORS, INSTALLERS, SUPPLIERS,

AND SPECIALISTS.

2. MEMBERS REPRESENTING OWNER, INCLUDING COMMISSIONING AGENT (CXA), FACILITY USER AND OPERATION AND MAINTENANCE PERSONNEL, AND ARCHITECT AND ENGINEERING DESIGN PROFESSIONALS.

B. CONTRACTOR'S RESPONSIBILITIES: CONTRACTOR SHALL ASSIGN REPRESENTATIVES WITH EXPERTISE AND AUTHORITY TO ACT ON ITS BEHALF AND SHALL SCHEDULE THEM TO PARTICIPATE IN AND PERFORM COMMISSIONING PROCESS ACTIVITIES INCLUDING, BUT NOT LIMITED TO, THE FOLLOWING:

THE FOLLOWING:

1. INTEGRATE AND COORDINATE COMMISSIONING PROCESS ACTIVITIES WITH CONSTRUCTION SCHEDULE.

REVIEW AND ACCEPT COMMISSIONING CHECKLISTS AND PROCESS
TEST PROCEDURES PROVIDED BY THE COMMISSIONING AGENT (CXA).
 SUPPORT COMMISSIONING INSTALLATION REVIEW AND PROCESS

TEST PROCEDURES.

4. EVALUATE INSTALLATION AND PERFORMANCE DEFICIENCIES IDENTIFIED IN REPORTS AND, IN COLLABORATION WITH ENTITY RESPONSIBLE FOR SYSTEM AND EQUIPMENT INSTALLATION, RECOMMEND CORRECTIVE ACTION.

5. COOPERATE WITH THE COMMISSIONING TEAM FOR RESOLUTION OF

ISSUES RECORDED IN THE ISSUES LOG.
COMMISSIONING AGENT'S (CXA'S) RESPONSIBILITIES:
1. ORGANIZE AND LEAD COMMISSIONING TEAM.

PROVIDE AND MANAGE COMMISSIONING PLAN.
 PROVIDE PROJECT-SPECIFIC CHECKLISTS AND TEST PROCEDURES.

 WITNESS, PREPARE AND MAINTAIN COMPLETED INSTALLATION VERIFICATION CHECKLISTS.
 WITNESS SYSTEMS, ASSEMBLIES, EQUIPMENT, AND COMPONENT

STARTUP.

6. WITNESS, PREPARE, AND MAINTAIN COMPLETED FUNCTIONAL

6. WITNESS, PREPARE, AND MAINTAIN COMPLETED TESTING CHECKLISTS.

 PREPARE AND MAINTAIN THE ISSUES LOG.
 COMPILE COMMISSIONING DOCUMENTS, RESULTS, AND DEFICIENCIES; INCLUDE THEM IN THE SYSTEMS MANUAL AND

COMMISSIONING SUMMARY REPORT.

9. REVIEW COMMISSIONING REPORT WITH COMMISSIONING TEAM AND IMPLEMENT PLAN TO RESOLVE DEFICIENCIES.

END OF SECTION 019113

EXISTING CONDITIONS

SECTION 024119 - SELECTIVE DEMOLITION

1.1 SUMMARY
 A. DEMOLITION AND REMOVAL OF SELECTED ELEMENTS.
 B. HISTORIC ITEMS REMOVED AND SALVAGED FOR OWNER.
 1.2 SUBMITTALS

A. SCHEDULE OF SELECTIVE DEMOLITION ACTIVITIES: INDICATE THE FOLLOWING:

1. DETAILED SEQUENCE OF SELECTIVE DEMOLITION AND REMOVAL WORK, WITH STARTING AND ENDING DATES FOR EACH ACTIVITY. ENSURE OWNER'S AND OTHER TENANTS' ON-SITE OPERATIONS ARE UNITERRUPTED.

 INTERRUPTION OF UTILITY SERVICES. INDICATE HOW LONG UTILITY SERVICES WILL BE INTERRUPTED.
 COORDINATION FOR SHUTOFF, CAPPING, AND CONTINUATION OF

UTILITY SERVICES.
4. USE OF ELEVATOR AND STAIRS.

 COORDINATION OF OWNER'S CONTINUING OCCUPANCY OF PORTIONS OF EXISTING BUILDING AND OF OWNER'S PARTIAL OCCUPANCY OF COMPLETED WORK.

1.3 PROJECT CONDITIONS

A. OWNER WILL OCCUPY PORTIONS OF BUILDING IMMEDIATELY

ADJACENT TO SELECTIVE DEMOLITION AREA.

B. HAZARDOUS MATERIALS: UNKNOWN WHETHER HAZARDOUS MATERIALS WILL
BE ENCOUNTERED. IF ENCOUNTERED, OWNER WILL REMOVE HAZARDOUS
MATERIALS UNDER A SEPARATE CONTRACT.

1.4 WARRANTY
A. EXISTING WARRANTIES: NOTIFY STARBUCKS CONSTRUCTION MANAGER OF WORK
AFFECTING EXISTING WARRENTIES PRIOR TO PROCEEDING WITH WORK

AFFECTING EXISTING WARRENTIES PRIOR TO PROCEEDING WITH WORK.

5 EXECUTION

A LITHITY SERVICES AND MECHANICAL (FLECTRICAL SYSTEMS: MAINTAINED TO

A. UTILITY SERVICES AND MECHANICAL/ELECTRICAL SYSTEMS: MAINTAINED TO OCCUPIED FACILITIES.
 1. SHUT OFF: BY CONTRACTOR WITH OWNER'S PERMISSION.

SITE ACCESS AND TEMPORARY CONTROLS: MINIMUM INTERFERENCE WITH ROADS, STREETS, WALKS, WALKWAYS, AND OTHER ADJACENT OCCUPIED AND USED FACILITIES
TEMPORARY FACILITIES: PROVIDE TEMPORARY BARRICADES AND OTHER

PROTECTION REQUIRED TO PREVENT INJURY TO PEOPLE AND DAMAGE TO ADJACENT BUILDINGS AND FACILITIES TO REMAIN.

D. TEMPORARY SHORING: PROVIDE AND MAINTAIN SHORING, BRACING, AND STRUCTURAL SUPPORTS AS REQUIRED TO PRESERVE STARILITY AND

STRUCTURAL SUPPORTS AS REQUIRED TO PRESERVE STABILITY AND PREVENT MOVEMENT, SETTLEMENT, OR COLLAPSE OF CONSTRUCTION AND FINISHES TO REMAIN, AND TO PREVENT UNEXPECTED OR UNCONTROLLED MOVEMENT OR COLLAPSE OF CONSTRUCTION BEING DEMOLISHED.

E. REMOVED AND SALVAGED ITEMS: CLEANED, CRATED, STORED, AND TRANSPORTED TO OWNER'S OFF-SITE STORAGE AREA.

F. REMOVED AND REINSTALLED ITEMS: CLEANED, REPAIRED, CRATED, STORED, AND REINSTALLED.

G. EXISTING ITEMS TO REMAIN: EXISTING CONSTRUCTION PROTECTED AGAINST DAMAGE.

H. DISPOSAL OF DEMOLISHED ITEMS:1. BURNING: NOT PERMITTED.

2. DISPOSAL: COMPLY WITH REQUIREMENTS SECTION 017419
"CONSTRUCTION WASTE MANAGEMENT AND DISPOSAL".

END OF SECTION 024119



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Seattle, Washington 98134
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Revision Schedule								
Rev	Rev Date By Description							

SANTA CLARA COUNT

Project Address:
403 SARATOG
SAN JOSE, CA
COUNTY: SAN

4/10/14

ANDREW

HUMAYDAN

A. HUMAYDEN

Store #: 20170

Project #: 55066-003

Concept: MCS

Palette:
Issue Date:
Design Manager:

LEED® AP:

Production Designer:
Checked by:

Sheet Title:

DESIGN SPECIFICATIONS

Sheet Number:

G-0010

lumber:

CONCRETE

SECTION 033000 - CAST-IN-PLACE CONCRETE

SUMMARY CAST-IN-PLACE CONCRETE, INCLUDING FORMWORK, REINFORCEMENT, CONCRETE MATERIALS, MIXTURE DESIGN, PLACEMENT PROCEDURES AND FINISHES, FOR THE FOLLOWING:

> FOUNDATION WALLS. SLABS-ON-GRADE.

> > GRID LINES

SUBMITTALS 1.2 PRODUCT DATA: FOR EACH TYPE OF PRODUCT INDICATED.

SHOP DRAWINGS: REINFORCING: PLACING DRAWINGS THAT DETAIL FABRICATION, BENDING, AND PLACEMENT. INCLUDE BAR SIZES, LENGTHS. MATERIAL, GRADE, BAR SCHEDULES, STIRRUP SPACING, BENT BAR DIAGRAMS, BAR ARRANGEMENT, SPLICES AND LAPS, MECHANICAL CONNECTIONS, TIE SPACING, HOOP SPACING, AND

SUPPORTS FOR CONCRETE REINFORCEMENT. SLAB LAYOUTS: DIMENSION LOCATIONS OF CONTROL EXPANSION, AND CONSTRUCTION JOINTS. RELATE TO BUILDING

DESIGN MIXTURES: FOR EACH CONCRETE MIXTURE. SUBMIT ALTERNATE DESIGN MIXTURES WHEN CHARACTERISTICS OF MATERIALS, PROJECT CONDITIONS, WEATHER, TEST RESULTS, OR OTHER CIRCUMSTANCES WARRANT ADJUSTMENTS.

INDICATE AMOUNTS OF MIXING WATER TO BE WITHHELD FOR LATER ADDITION AT PROJECT SITE.

CERTIFICATIONS: SUBMIT MILL CERTIFICATES FOR CEMENT, AGGREGATES, AND REINFORCING

1.3 MATERIALS

STEEL REINFORCEMENT: REINFORCING BARS: DEFORMED

MINIMUM RECYCLED CONTENT: 60% PLAIN-STEEL WELDED WIRE REINFORCEMENT: ASTM A 185. PLAIN, FABRICATED FROM AS-DRAWN STEEL WIRE INTO FLAT

CONCRETE MATERIALS:

PORTLAND CEMENT: ASTM C 150, TYPE I, GRAY, SUPPLEMENT WITH THE FOLLOWING:

FLY ASH: ASTM C 618, CLASS F OR C.

GROUND GRANULATED BLAST-FURNACE SLAG: ASTM C989, GRADE 100 OR 120.

AGGREGATE: NORMAL WEIGHT WATER: ASTM C 94/C 94M.

ADMIXTURES: PROVIDE ADMIXTURES CERTIFIED BY MANUFACTURER TO BE COMPATIBLE WITH OTHER ADMIXTURES AND THAT WILL NOT CONTRIBUTE WATER-SOLUBLE CHLORIDE IONS EXCEEDING THOSE PERMITTED IN HARDENED CONCRETE DO NOT USE CALCIUM CHLORIDE OR ADMIXTURES CONTAINING CALCIUM CHLORIDE.

AIR-ENTRAINMENT: ASTM C 260.

WATER-REDUCING ADMIXTURE: ASTM C 494/C 494M,

HIGH-RANGE, WATER-REDUCING ADMIXTURE: ASTM C494/C 494M, TYPE F

WATERSTOPS: FLEXIBLE RUBBER PLASTIC VAPOR RETARDER: ASTM E 1745, CLASS A. INCLUDE MANUFACTURER'S RECOMMENDED ADHESIVE OR PRESSURE-SENSITIVE

CURING MATERIALS: WATERBORNE, MONOMOLECULAR FILM FORMING, MANUFACTURED FOR APPLICATION TO FRESH CONCRETE.

RELATED MATERIALS: EXPANSION- AND ISOLATION-JOINT-FILLER STRIPS ASTM D 1751 ASPHALT-SATURATED CELLULOSIC FIBER OR ASTM D 1752, CORK OR SELF-EXPANDING CORK.

BONDING AGENT: ASTM C 1059/C 1059M, TYPE II, NON-REDISPERSIBLE, ACRYLIC EMULSION OR STYRENE BUTADIENE.

NON-SHRINK GROUTS: ASTM C 1107, GRADE B; NON-SHRINK NON-CATALYZED NATURAL AGGREGATE GROUT: MINIMUM COMPRESSIVE STRENGTH OF 7000 PSI AT 28 DAYS; 25 TO 30 SECOND FLOW WHEN TESTED IN ACCORDANCE WITH ASTM C 939 AT 45 TO 90 DEGREES F; CEMENT GRAY IN COLOR

FORM RELEASE COATING: WATER BASED TYPE; VOC <150G/I; NOX-CRETE "UTILITY RELEASE. CRESSET CHEMICAL COMPANY CRETE 20 VOC," OR APPROVED; NON STAINING.

REPAIR MATERIALS:

REPAIR UNDERLAYMENT: CEMENT-BASED, POLYMER-MODIFIED SELF-LEVELING PRODUCT THAT CAN BE APPLIED IN THICKNESSES FROM 1/8 INCH (3.2 MM) AND THAT CAN BE FEATHERED AT EDGES TO MATCH ADJACENT FLOOR ELEVATIONS.

CEMENT BINDER: ASTM C 150, PORTLAND CEMENT OR HYDRAULIC OR BLENDED HYDRAULIC CEMENT AS DEFINED IN ASTM C 219.

PRIMER: PRODUCT OF UNDERLAYMENT MANUFACTURER RECOMMENDED FOR SUBSTRATE, CONDITIONS, AND

AGGREGATE: WELL-GRADED, WASHED GRAVEL, 1/8 TO 1/4 INCH (3.2 TO 6 MM) OR COARSE SAND AS RECOMMENDED BY UNDERLAYMENT MANUFACTURER

COMPRESSIVE STRENGTH: NOT LESS THAN 4100 PSI (29 MPA) AT 28 DAYS WHEN TESTED ACCORDING TO ASTM C 109/C 109M.

REPAIR OVERLAYMENT: CEMENT-BASED, POLYMER-MODIFIED. SELF-LEVELING PRODUCT HAT CAN BE APPLIED IN THICKNESSES FROM 1/8 INCH (3.2 MM) AND THAT CAN BE FEATHERED AT EDGES TO MATCH ADJACENT FLOOR ELEVATIONS. CEMENT BINDER: ASTM C 150, PORTLAND CEMENT OR

> HYDRAULIC OR BLENDED HYDRAULIC CEMENT AS DEFINED IN ASTM C 219. PRIMER: PRODUCT OF TOPPING MANUFACTURER RECOMMENDED FOR SUBSTRATE, CONDITIONS, AND

APPLICATION. AGGREGATE: WELL-GRADED, WASHED GRAVEL, 1/8 TO 1/4 INCH (3.2 TO 6 MM) OR COARSE SAND AS

RECOMMENDED BY TOPPING MANUFACTURER. COMPRESSIVE STRENGTH: NOT LESS THAN 5000 PSI (34.5 MPA) AT 28 DAYS WHEN TESTED ACCORDING TO

1.4 INSTALLATION

FLOOR AND SLAB FINISHES:

FLOAT: SURFACES TO RECEIVE TROWEL FINISH. TROWEL: SURFACES EXPOSED TO VIEW, AND SURFACES TO BE COVERED WITH RESILIENT FLOORING, CARPET, CERAMIC OR QUARRY TILE SET OVER A CLEAVAGE MEMBRANE, PAINT, OR ANOTHER THIN-FILM-FINISH COATING SYSTEM.

TROWEL AND FINE BROOM: SURFACES TO BE COVERED WITH CERAMIC OR QUARRY TILE INSTALLED BY EITHER THICKSET OR THIN-SET METHOD.

BROOM: EXTERIOR CONCRETE PLATFORMS, STEPS, AND RAMPS. FIELD QUALITY CONTROL

TESTING: BY [OWNER] [CONTRACTOR]-ENGAGED AGENCY. INSPECTIONS: BY OWNER-ENGAGED SPECIAL INSPECTOR.

ASTM C 109/C 109M.

END OF SECTION 033000

CONCRETE (CONTINUED)

SECTION 033500 - CONCRETE FINISHING

SUBMITTALS QUALIFICATION DATA: FOR QUALIFIED APPLICATOR

MATERIAL CERTIFICATES. FLOOR AND SLAB TREATMENTS

VOC CONTENT: FLOOR TREATMENTS SHALL HAVE A VOC CONTENT OF 200 G/L OR LESS WHEN CALCULATED ACCORDING TO 40 CFR 59, SUBPART D (EPA

UNPIGMENTED MINERAL DRY-SHAKE FLOOR HARDENER: FACTORY-PACKAGED DRY COMBINATION OF PORTLAND CEMENT, GRADED QUARTZ AGGREGATE, AND PLASTICIZING ADMIXTURE.

PIGMENTED MINERAL DRY-SHAKE FLOOR HARDENER: FACTORY-PACKAGED, DRY COMBINATION OF PORTLAND CEMENT, GRADED QUARTZ AGGREGATE. COLOR PIGMENTS, AND PLASTICIZING ADMIXTURE. USE COLOR PIGMENTS THAT ARE FINELY GROUND, NONFADING MINERAL OXIDES INTERGROUND WITH CEMENT.

LIQUID FLOOR TREATMENTS VOC CONTENT: LIQUID FLOOR TREATMENTS SHALL HAVE A VOC CONTENT OF 200 G/L OR LESS WHEN CALCULATED ACCORDING TO 40 CFR 59, SUBPART D

(FPA METHOD 24) PENETRATING LIQUID FLOOR TREATMENT: CLEAR, CHEMICALLY REACTIVE, WATERBORNE SOLUTION OF INORGANIC SILICATE OR SILICONATE MATERIALS AND PROPRIETARY COMPONENTS; ODORLESS; THAT PENETRATES, HARDENS, AND DENSIFIES CONCRETE SURFACES.

PENETRATING LIQUID FLOOR TREATMENTS FOR POLISHED CONCRETE FINISH: CLEAR, WATERBORNE SOLUTION OF INORGANIC SILICATE OR SILICONATE MATERIALS AND PROPRIETARY COMPONENTS; ODORLESS; THAT PENETRATES, HARDENS, AND IS SUITABLE FOR POLISHED CONCRETE SURFACES.

INSTALLATION DRY-SHAKE FLOOR HARDENER FINISH: AFTER INITIAL FLOATING, APPLY DRY-

SHAKE FLOOR HARDENER TO SURFACES PENETRATING LIQUID FLOOR TREATMENT: PREPARE, APPLY, AND FINISH PENETRATING LIQUID FLOOR TREATMENT ACCORDING TO MANUFACTURER'S

WRITTEN INSTRUCTIONS. SEALING COAT: UNIFORMLY APPLY A CONTINUOUS SEALING COAT OF CURING AND SEALING COMPOUND TO HARDENED CONCRETE BY POWER SPRAY OR ROLLER ACCORDING TO MANUFACTURER'S WRITTEN INSTRUCTIONS.

PROTECT LIQUID FLOOR TREATMENT FROM DAMAGE AND WEAR DURING THE REMAINDER OF CONSTRUCTION PERIOD. USE PROTECTIVE METHODS AND MATERIALS, INCLUDING TEMPORARY COVERING, RECOMMENDED IN WRITING BY LIQUID FLOOR TREATMENTS INSTALLER.

END OF SECTION 033500

SECTION 035416 - HYDRAULIC-CEMENT-BASED UNDERLAYMENT

HYDRAULIC-CEMENT-BASED UNDERLAYMENT FOR USE BELOW INTERIOR FLOOR COVERINGS.

UNDERLAYMENT: HYDRAULIC-CEMENT-BASED, POLYMER-MODIFIED, SELF-LEVELING PRODUCT THAT CAN BE APPLIED IN MINIMUM UNIFORM THICKNESS OF 1/4 INCH (6MM) AND THAT CAN BE FEATHERED AT EDGES TO MATCH ADJACENT FLOOR ELEVATIONS. CEMENT BINDER: PORTLAND CEMENT, OR OTHER HYDRAULIC OR

BLENDED HYDRAULIC CEMENT. PRIMER: PRODUCT OF UNDERLAYMENT MANUFACTURER RECOMMENDED IN WRITING FOR SUBSTRATE, CONDITIONS, AND APPLICATION INDICATED. PRIMER SHALL HAVE A VOC CONTENT OF 200 G/L OR LESS WHEN

CALCULATED ACCORDING TO 40 CFR 59, SUBPART D **END OF SECTION 035416**

METALS

SECTION 055000 - METAL FABRICATIONS SUMMARY

STEEL FRAMING AND SUPPORTS FOR MECHANICAL AND ELECTRICAL

STEEL FRAMING AND SUPPORTS FOR APPLICATIONS WHERE FRAMING AND SUPPORTS ARE NOT SPECIFIED IN OTHER SECTIONS.

SHELF ANGLES. METAL BOLLARDS SUBMITTALS

PRODUCT DATA: FOR THE FOLLOWING:

PAINT PRODUCTS.

ALL PREFABRICATED PRODUCTS. SHOP DRAWINGS: SHOW FABRICATION AND INSTALLATION DETAILS FOR

METAL FABRICATIONS. INCLUDE PLANS, ELEVATIONS, SECTIONS, AND DETAILS OF METAL FABRICATIONS AND THEIR CONNECTIONS. SHOW ANCHORAGE AND

PROVIDE TEMPLATES FOR ANCHORS AND BOLTS SPECIFIED FOR INSTALLATION UNDER OTHER SECTIONS.

WELDING CERTIFICATES.

PRODUCTS MATERIALS: STEEL PLATES, SHAPES, AND BARS, STEEL PIPE, SLOTTED

CHANNEL FRAMING. LOW-EMITTING PRIMER: METAL PRIMER SHALL HAVE A VOC CONTENT OF 200 G/L OR LESS WHEN CALCULATED ACCORDING TO 40 CFR 59. SUBPART D (EPA METHOD 24).

MISCELLANEOUS FRAMING AND SUPPORTS STEEL FRAMING AND SUPPORTS FOR MECHANICAL AND ELECTRICAL EQUIPMENT, APPLICATIONS WHERE FRAMING AND SUPPORTS ARE

NOT SPECIFIED IN OTHER SECTIONS GALVANIZE WHERE INDICATED. PRIME WITH ZINC-RICH PRIMER WHERE INDICATED.

ZINC-RICH PRIMER SHALL HAVE A VOC CONTENT OF 340 G/L OR LESS WHEN CALCULATED ACCORDING TO 40 CFR 59,

SHELF ANGLES, GALVANIZED.

STEEL WELD PLATES AND ANGLES NOT SPECIFIED IN OTHER SECTIONS, FOR CASTING INTO CONCRETE.

END OF SECTION 055000

SUBPART D (EPA METHOD 24). LOOSE STEEL LINTELS, GALVANIZED AT EXTERIOR WALLS.

METAL BOLLARDS: SCHEDULE 40 STEEL PIPE.

SECTION 061053 - MISCELLANEOUS ROUGH CARPENTRY MATERIALS

WOOD AND PLASTICS

WOOD PRODUCTS, GENERAL MAXIMUM MOISTURE CONTENT OF LUMBER: 19 PERCENT.

WOOD-PRESERVATIVE-TREATED MATERIALS: PRESERVATIVE TREATMENT: AWPA U1; USE CATEGORY UC2. PRESERVATIVE CHEMICALS: CONTAINING NO ARSENIC OR

CHROMIUM. DO NOT USE INORGANIC BORON (SBX) FOR SILL APPLICATION: ITEMS INDICATED AND THE FOLLOWING: ITEMS IN CONTACT WITH ROOFING OR WATERPROOFING.

ITEMS IN CONTACT WITH CONCRETE OR MASONRY. FRAMING LESS THAN 18 INCHES (460 MM) ABOVE GROUND IN CRAWLSPACES.

FLOOR PLATES INSTALLED OVER CONCRETE SLABS-ON-GRADE FIRE-RETARDANT-TREATED MATERIALS: EXTERIOR TYPE FOR EXTERIOR LOCATIONS AND WHERE INDICATED.

INTERIOR TYPE A UNLESS OTHERWISE INDICATED. APPLICATION: ITEMS INDICATED AND THE FOLLOWING: FRAMING FOR RAISED PLATFORMS

CONCEALED BLOCKING ROOF FRAMING AND BLOCKING. ITEMS IN CONTACT WITH ROOFING PLYWOOD BACKING PANELS.

FRAMING: NON-LOAD-BEARING INTERIOR PARTITIONS: CONSTRUCTION OR NO. 2

MISCELLANEOUS LUMBER:

DIMENSION LUMBER: CONSTRUCTION OR NO. 2 GRADE UTILITY SHELVING: 19 PERCENT MAXIMUM MOISTURE CONTENT. CONCEALED BOARDS: 19 PERCENT MAXIMUM MOISTURE CONTENT PLYWOOD BACKING PANELS: EXPOSURE 1, C-D PLUGGED, FIRE-RETARDANT

FASTENERS: HOT-DIP GALVANIZED STEEL WHERE EXPOSED TO WEATHER, IN GROUND CONTACT, IN CONTACT WITH TREATED WOOD, OR IN AREA OF HIGH RELATIVE HUMIDITY. METAL FRAMING ANCHORS:

METAL: GALVANIZED STEEL; HOT-DIP HEAVY GALVANIZED STEEL FOR WOOD-PRESERVATIVE-TREATED LUMBER AND WHERE INDICATED. ADHESIVES: ADHESIVES SHALL HAVE A VOC CONTENT OF 70 G/L OR LESS WHEN CALCULATED ACCORDING TO 40 CFR 59, SUBPART D (EPA METHOD 24)

INSTALLATION FURRING TO RECEIVE PLYWOOD OR HARDBOARD PANELING: 1-BY-3-INCH NOMINAL-SIZE (19-BY-63-MM ACTUAL-SIZE) FURRING AT 24 INCHES O.C. FURRING TO RÈCEIVE GYPSUM BOARD: 1-BY-2-INCH NOMINAL-SIZE (19-BY-38-

MM ACTUAL-SIZE) FURRING AT 16 INCHES O.C. **END OF SECTION 061053**

SECTION 064000 - INTERIOR ARCHITECTURAL WOODWORK SUMMARY

INTERIOR STANDING AND RUNNING TRIM. FLUSH WOOD PANELING AND WAINSCOTS. MELAMINE CABINETS. SOLID-SURFACING-MATERIAL COUNTERTOPS CLOSET AND UTILITY SHELVING.

QUALITY ASSURANCE QUALITY STANDARD: AWI. 1.3

MATERIALS WOOD PRODUCTS: COMPLY WITH THE FOLLOWING:

HARDBOARD: AHA A135.4, MADE WITH BINDER CONTAINING NO UREA FORMALDEHYDE. MEDIUM-DENSITY FIBERBOARD: ANSI A208.2, GRADE 130, MADE WITH BINDER CONTAINING NO UREA FORMALDEHYDE. MOISTURE RESISTANT MEDIUM-DENSITY FIBERBOARD:

ANSI A208.2, GRADE MD, MR50, MADE WITH BINDER CONTAINING NO UREA FORMALDEHYDE. STRAW-BASED PARTICLEBOARD: ANSI A208.1, GRADE M-2, EXCEPT FOR DENSITY, MADE WITH ADHESIVE CONTAINING NO

UREA FORMALDEHYDE. SOFTWOOD PLYWOOD: DOC PS 1 VENEER-FACED PANEL PRODUCTS (HARDWOOD PLYWOOD):

HPVA HP-1, MADE WITH ADHESIVE CONTAINING NO UREA FORMALDEHYDE. ADHESIVES, GENERAL: DO NOT USE ADHESIVES THAT CONTAIN

UREA FORMALDEHYDE VOC LIMITS FOR INSTALLATION ADHESIVES AND GLUES: USE INSTALLATION ADHESIVES THAT COMPLY WITH THE FOLLOWING LIMITS FOR VOC CONTENT WHEN CALCULATED ACCORDING TO 40 CFR 59. SUBPART D (EPA METHOD 24):

WOOD GLUES: 30 G/L PANEL ADHESIVE: 50 G/L MULTIPURPOSE CONSTRUCTION ADHESIVE: 70 G/L CONTACT ADHESIVE: 80 G/L

SPECIAL PURPOSE: 250 G/L CLOSET AND UTILITY SHELVING:

SHELF MATERIAL: 3/4 INCH (19 MM) THERMOSET DECORATIVE PANEL WITH PVC OR POLYESTER EDGE BANDING.

CLEATS: 3/4 INCH (19 MM) PANEL PRODUCT. SHOP FINISHING: GRADE: SAME GRADE AS WOODWORK. EXTENT: ALL WOODWORK SHOP FINISHED.

INSTALLATION

SCRIBE AND CUT MILLWORK TO FIT ADJOINING WORK, REFINISH CUT

SURFACES, AND REPAIR DAMAGED FINISH AT CUTS. ANCHOR MILLWORK TO ANCHORS OR BLOCKING BUILT IN OR DIRECTLY ATTACHED TO SUBSTRATES. SECURE WITH COUNTERSUNK, CONCEALED FASTENERS AND BLIND NAILING AS REQUIRED FOR COMPLETE INSTALLATION. USE FINE FINISHING NAILS OR FINISHING SCREWS FOR EXPOSED FASTENING, COUNTERSUNK AND FILLED FLUSH WITH MILLWORK AND MATCHING FINAL FINISH IF TRANSPARENT FINISH

CABINETS: INSTALL WITHOUT DISTORTION SO DOORS AND DRAWERS FIT OPENINGS PROPERLY AND ARE ACCURATELY ALIGNED. ADJUST HARDWARE TO CENTER DOORS AND DRAWERS IN OPENINGS AND TO PROVIDE UNENCUMBERED OPERATION. COMPLETE INSTALLATION OF HARDWARE AND ACCESSORY ITEMS AS INDICATED.

INSTALL CABINETS WITH NO MORE THAN 1/8 INCH IN 96 INCH (3 MM IN 2400 MM) SAG, BOW, OR OTHER VARIATION FROM A COUNTERTOPS: ANCHOR SECURELY BY SCREWING THROUGH CORNER

BLOCKS OF BASE CABINETS OR OTHER SUPPORTS INTO UNDERSIDE OF COUNTERTOP ALIGN ADJACENT SOLID-SURFACING-MATERIAL COUNTERTOPS AND FORM SEAMS TO COMPLY WITH MANUFACTURER'S WRITTEN RECOMMENDATIONS USING ADHESIVE IN COLOR TO MATCH COUNTERTOP. CAREFULLY DRESS JOINTS SMOOTH, REMOVE

INSTALL COUNTERTOPS WITH NO MORE THAN 1/8 INCH IN 96 INCH (3 MM IN 2400 MM) SAG, BOW, OR OTHER VARIATION FROM A STRAIGHT LINE.

SURFACE SCRATCHES, AND CLEAN ENTIRE SURFACE.

SECURE COVED BACKSPLASHES TO TOPS PER MANUFACTURES FABRICATION MANUAL AND TO WALLS WITH ADHESIVE.

CALK SPACE BETWEEN BACKSPLASH AND WALL WITH SEALANT SPECIFIED IN DIVISION 7 SECTION "JOINT SEALANTS." **END OF SECTION 064000**

WOOD AND PLASTICS (CONTINUED)

SECTION 064400 - PLASTIC PANELING

PART 1 - GENERAL 1.1 SUMMARY

SECTION INCLUDES THE FOLLOWING: GLASS-FIBER REINFORCED PLASTIC (FRP) WALL PANELING.

MOLDING, ADHESIVES, AND JOINT SEALANTS. 1.2 PLASTIC SHEET PANELING GLASS-FIBER-REINFORCED PLASTIC PANELING: GELCOAT-FINISHED, GLASS-FIBER REINFORCED PLASTIC PANELS COMPLYING WITH ASTM D 5319. LOW-EMITTING MATERIALS: PANELING SHALL COMPLY WITH THE TESTING AND PRODUCT REQUIREMENTS OF THE CALIFORNIA DEPARTMENT OF HEALTH SERVICES' "STANDARD PRACTICE FOR THE TESTING OF VOLATILE ORGANIC EMISSIONS FROM VARIOUS SOURCES USING SMALL-SCALE ENVIRONMENTAL CHAMBERS.

NOMINAL THICKNESS: NOT LESS THAN 0.09 INCHES. COLOR: WHITE. MOLDING COLOR: WHITE.

SURFACE FINISH: MOLDED PEBBLE TEXTURE. UNREINFORCED POLYPROPYLENE PANELING: SOLID POLYPROPYLENE PANELS MADE FROM NO LESS THAN 80 PERCENT RECYCLED MATERIAL. LOW-EMITTING MATERIALS: PANELING SHALL COMPLY WITH THE TESTING AND PRODUCT REQUIREMENTS OF THE CALIFORNIA DEPARTMENT OF PUBLIC HEALTH'S (FORMERLY, THE CALIFORNIA DEPARTMENT OF HEALTH SERVICES') "STANDARD METHOD FOR THE TESTING AND EVALUATION OF VOLATILE ORGANIC CHEMICAL EMISSIONS FROM INDOOR SOURCES USING ENVIRONMENTAL CHAMBERS.

NOMINAL THICKNESS: NOT LESS THAN 0.09 INCHES. COLOR: WHITE MOLDING COLOR: WHITE.

SURFACE FINISH: MOLDED PEBBLE TEXTURE. **ADHESIVES**

AS RECOMMENDED BY PLASTIC PANELING MANUFACTURER. VOC LIMIT: 50 G/L ACCESSORIES

TRIM ACCESSORIES: MANUFACTURER'S STANDARD ONE-PIECE VINYL EXTRUSIONS DESIGNED TO RETAIN AND COVER EDGES OF PANELS. PROVIDE DIVISION BARS, INSIDE CORNERS, OUTSIDE CORNERS, AND CAPS AS NEEDED TO CONCEAL EDGES. COLOR: WHITE

END OF SECTION 064400

THERMAL AND MOISTURE PROTECTION

SECTION 07841 - THROUGH-PENETRATION FIRESTOP SYSTEMS

SUBMITTALS PRODUCT DATA: FOR EACH TYPE OF PRODUCT INDICATED. QUALITY ASSURANCE

INSTALLER QUALIFICATIONS: AN FM GLOBAL-APPROVED FIRESTOP CONTRACTOR OR A UL-QUALIFIED FIRESTOP CONTRACTOR. FIRE-TEST-RESPONSE CHARACTERISTICS: TESTED PER ASTM E 814 BY

QUALIFIED TESTING AND INSPECTING AGENCY. 1.3 PENETRATION FIRESTOPPING PENETRATIONS IN FIRE-RESISTANCE-RATED WALLS: F-RATINGS PER

ASTM E 814 OR UL 1479. PENETRATIONS IN HORIZONTAL ASSEMBLIES: F- AND T-RATINGS PER ASTM E 814 OR UL 1479:

PENETRATIONS IN SMOKE BARRIERS: L-RATINGS PER UL 1479. W-RATINGS: PER UL 1479. VOC CONTENT OF INTERIOR SEALANTS: PROVIDE INTERIOR SEALANTS AND SEALANT PRIMERS THAT COMPLY WITH THE FOLLOWING LIMITS FOR VOC CONTENT WHEN CALCULATED ACCORDING TO 40 CFR 59, SUBPART D

SEALANTS: 250 G/L SEALANT PRIMERS FOR NONPOROUS SUBSTRATES: 250 G/L SEALANT PRIMERS FOR POROUS SUBSTRATES: 775 G/L.

1.4 INSTALLATION IDENTIFICATION: PREPRINTED METAL OR PLASTIC LABELS. PERMANENTLY ATTACHED. FIELD QUALITY CONTROL

AGENCY ACCORDING TO ASTM E 2174 REQUIREMENTS.

FIRE-RESISTIVE JOINT SYSTEMS

END OF SECTION 07841

SECTION 078446 - FIRE-RESISTIVE JOINT SYSTEMS 1.1 SUMMARY A. FIRE-RESISTIVE JOINT SYSTEMS FOR THE FOLLOWING: JOINTS IN OR BETWEEN FIRE-RESISTANCE-RATED CONSTRUCTIONS. JOINTS AT EXTERIOR CURTAIN-WALL/FLOOR INTERSECTIONS.

INSPECTION OF INSTALLED FIRESTOP SYSTEMS: BY OWNER-ENGAGED

JOINTS IN SMOKE BARRIERS. PERFORMANCE REQUIREMENTS FIRE-RESISTANCE RATINGS OF JOINT SYSTEMS IN AND BETWEEN FIRE-RESISTANCE-RATED CONSTRUCTIONS: EQUALING OR EXCEEDING THE FIRE-RESISTANCE RATINGS OF CONSTRUCTION THAT THEY JOIN, [AND WITH

MOVEMENT CAPABILITIES INDICATED] AS DETERMINED BY UL 2079. SUBMITTALS

PRODUCT DATA: FOR EACH TYPE OF PRODUCT INDICATED. QUALITY ASSURANCE FIRE-TEST-RESPONSE CHARACTERISTICS: TESTED BY QUALIFIED TESTING AND INSPECTING AGENCY.

DESIGNATION SYSTEM FOR JOINTS IN OR BETWEEN FIRE-RESISTANCE-RATED CONSTRUCTIONS: ALPHANUMERIC SYSTEMS LISTED IN UL'S "FIRE RESISTANCE DIRECTORY" UNDER PRODUCT CATEGORY XHBN.

EXCEEDING THE FIRE-RESISTANCE RATING OF THE FLOOR ASSEMBLY.

EXPOSED FIRE-RESISTIVE JOINT SYSTEMS: PROVIDE PRODUCTS WITH

JOINTS IN OR BETWEEN FIRE-RESISTANCE-RATED CONSTRUCTION: EQUAL TO OR EXCEEDING THE FIRE-RESISTANCE RATING OF CONSTRUCTION THEY WILL JOINTS AT EXTERIOR CURTAIN-WALL/FLOOR INTERSECTIONS: EQUAL TO OR

JOINTS IN SMOKE BARRIERS: L-RATING: NOT EXCEEDING 5.0 CFM/FT (0.00775 CU. M/S X M) OF JOINT AT 0.30 INCH WG (74.7 PA) AT BOTH AMBIENT AND ELEVATED TEMPERATURES

FLAME-SPREAD AND SMOKE-DEVELOPED INDEXES OF LESS THAN 25 AND 450, RESPECTIVELY, AS DETERMINED PER ASTM E 84. VOC CONTENT: FIRE-RESISTIVE JOINT SYSTEM SEALANTS SHALL COMPLY WITH THE FOLLOWING LIMITS FOR VOC CONTENT WHEN CALCULATED

SEALANT PRIMERS FOR NONPOROUS SUBSTRATES: 250 G/L SEALANT PRIMERS FOR POROUS SUBSTRATES: 775 G/L ACCESSORIES: FORMING MATERIALS AND OTHER COMPONENTS NEEDED

ARCHITECTURAL SEALANTS: 250 G/L

ACCORDING TO 40 CFR 59, SUBPART D (EPA METHOD 24):

TO INSTALL FILL MATERIALS AND MAINTAIN RATINGS REQUIRED. **END OF SECTION 078446**

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Revision Schedule Description

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Store #: 20170 | Project # 55066-003

MCS

4/10/14

ANDREW

HUMAYDAN

A. HUMAYDEN

Issue Date: Design Manager: LEED® AP:

Concept:

Palette:

Production Designer Checked by:

Sheet Title: DESIGN **SPECIFICATIONS**

Sheet Number:

THERMAL AND MOISTURE PROTECTION (CONT)

SECTION 079200 - JOINT SEALANTS

- 1.1 MATERIALS VOC CONTENT OF INTERIOR SEALANTS: PROVIDE INTERIOR SEALANTS AND
 - SEALANT PRIMERS THAT COMPLY WITH THE FOLLOWING LIMITS FOR VOC CONTENT WHEN CALCULATED ACCORDING TO 40 CFR 59, SUBPART D (EPA METHOD 24): SEALANTS: 250 G/L.
 - SEALANT PRIMERS FOR NONPOROUS SUBSTRATES: 250 G/L SEALANT PRIMERS FOR POROUS SUBSTRATES: 775 G/L.
 - SUITABILITY FOR CONTACT WITH FOOD: WHERE SEALANTS ARE INDICATED FOR JOINTS THAT WILL COME IN REPEATED CONTACT WITH FOOD. PROVIDE PRODUCTS THAT COMPLY WITH 21 CFR 177.2600.
 - ELASTOMERIC JOINT SEALANTS: LIQUID APPLIED, CHEMICALLY CURING; ASTM C 920.
 - SINGLE-COMPONENT MILDEW-RESISTANT NEUTRAL-CURING

MULTICOMPONENT NONSAG NEUTRAL-CURING SILICONE SEALANT

- SILICONE SEALANT ES-2.
- SINGLE-COMPONENT MILDEW-RESISTANT ACID-CURING SILICONE SEALANT ES-3. SINGLE-COMPONENT MILDEW-RESISTANT ACID-CURING RTV
- SILICONE SEALANT ES-4.
- MULTICOMPONENT NONSAG POLYUREA SEALANT ES-5. MULTICOMPONENT NONSAG POLYUREA FILLER ES-6.
- LATEX SEALANT LS-1: COMPLY WITH ASTM C 834, TYPE P, GRADE NF JOINT-SEALANT BACKING:
- 1.2 JOINT-SEALANT SCHEDULE JOINT-SEALANT APPLICATION JS-1: EXTERIOR HORIZONTAL NONTRAFFIC AND TRAFFIC ISOLATION AND CONTRACTION JOINTS IN CAST-IN-PLACE
 - JOINT SEALANT: ES-5. JOINT-SEALANT APPLICATION JS-2: EXTERIOR PERIMETER JOINTS BETWEEN WALL AND FRAMES OF DOORS AND WINDOWS.
 - JOINT SEALANT: ES-1. JOINT-SEALANT APPLICATION JS-3: EXTERIOR CONTROL AND EXPANSION JOINTS IN HORIZONTAL TRAFFIC SURFACES OF BRICK PAVERS, CERAMIC TILE, STONE PAVING UNITS, CONCRETE TILE.
 - JOINT SEALANT: MULTICOMPONENT POURABLE POLYSULFIDE JOINT-SEALANT COLOR: AS SELECTED BY ARCHITECT FROM
 - MANUFACTURER'S FULL RANGE. JOINT-SEALANT APPLICATION JS-4: INTERIOR PERIMETER JOINTS OF
 - JOINT SEALANT: ES-3. JOINT-SEALANT APPLICATION JS-5: INTERIOR CERAMIC TILE EXPANSION, CONTROL, CONTRACTION, AND ISOLATION JOINTS IN HORIZONTAL TRAFFIC
 - JOINT SEALANT: ES-3.
 - JOINT-SEALANT COLOR: AS NOTED. JOINT-SEALANT APPLICATION JS-6: INTERIOR JOINTS BETWEEN PLUMBING FIXTURES AND ADJOINING WALLS, FLOORS, AND COUNTERS.
 - JOINT SEALANT: ES-3. JOINT-SEALANT COLOR: TRANSLUCENT.
 - JOINT-SEALANT APPLICATION JS-7: VERTICAL JOINTS ON EXPOSED
 - SURFACES OF INTERIOR PARTITIONS. JOINT SEALANT: ES-3.
 - JOINT-SEALANT APPLICATION JS-8: PERIMETER JOINTS BETWEEN INTERIOR WALL SURFACES AND FRAMES OF INTERIOR DOORS, WINDOWS. JOINT SEALANT: ES-3.
 - JOINT-SEALANT APPLICATION JS-9: HVAC JOINTS. JOINT SEALANT: ES-2.
 - JOINT-SEALANT COLOR: ALUMINUM. JOINT-SEALANT APPLICATION JS-10: NON-POROUS MATERIAL TO NON-POROUS MATERIAL
 - JOINT SEALANT: ES-4. JOINT-SEALANT COLOR: CLEAR.

DOORS AND WINDOWS

SECTION 081416 - FLUSH WOOD DOORS

END OF SECTION 079200

- SUBMITTALS PRODUCT DATA: FOR EACH TYPE OF DOOR INDICATED. INCLUDE DETAILS
- OF CORE AND EDGE CONSTRUCTION AND TRIM FOR OPENINGS. SHOP DRAWINGS: INDICATE LOCATION, SIZE, AND HAND OF EACH DOOR; ELEVATION OF EACH KIND OF DOOR: CONSTRUCTION DETAILS NOT COVERED IN PRODUCT DATA; LOCATION AND EXTENT OF HARDWARE BLOCKING; AND OTHER PERTINENT DATA.
 - INDICATE DIMENSIONS AND LOCATIONS OF MORTISES AND HOLES
 - FOR HARDWARE. INDICATE DIMENSIONS AND LOCATIONS OF CUTOUTS.
 - INDICATE REQUIREMENTS FOR VENEER MATCHING.
 - INDICATE DOORS TO BE FACTORY FINISHED AND FINISH REQUIREMENTS
- INDICATE FIRE-PROTECTION RATINGS FOR FIRE-RATED DOORS. WARRANTY: SAMPLE OF SPECIAL WARRANTY.
- 1.2 QUALITY ASSURANCE QUALITY STANDARD: AWI.
 - AWI QUALITY CERTIFICATION LABELS OR AN AWI LETTER OF LICENSING FOR DOORS.
 - WI-CERTIFIED COMPLIANCE CERTIFICATE FOR DOORS AND
- INSTALLATION. FIRE-RATED WOOD DOORS: POSITIVE PRESSURE TESTING.
- 1.3 DOOR CONSTRUCTION, GENERAL LOW-EMITTING MATERIALS: MADE WITH ADHESIVES AND COMPOSITE WOOD
- PRODUCTS THAT DO HAVE NO ADDED UREA FORMALDEHYDE. WDMA I.S.1-A PERFORMANCE GRADE: HEAVY DUTY UNLESS OTHERWISE
- VENEERED-FACED DOORS FOR TRANSPARENT FINISH INTERIOR SOLID-CORE DOORS:
 - CORE: PARTICLEBOARD.
- CONSTRUCTION: FIVE OR SEVEN PLIES, BONDED. PRIMING/FINISHING
- SHOP PRIMING:
 - DOORS FOR OPAQUE FINISH: ONE COAT OF WOOD PRIMER. DOORS FOR TRANSPARENT FINISH: STAIN AND FIRST COAT OF
- B. FACTORY FINISHING: ALL DOORS.

END OF SECTION 081416

DOORS AND WINDOWS (CONTINUED)

SECTION 08345 - DOUBLE ACTING SWING DOORS

PART 1 - GENERAL 1.1 SUMMARY

SECTION INCLUDES:

SOLID-CORE DOUBLE ACTING SWING DOORS WITH PLASTIC LAMINATE FACES.

SUBMITTALS PRODUCT DATA: FOR EACH TYPE OF PRODUCT INDICATED. INCLUDE CONSTRUCTION DETAILS, MATERIAL DESCRIPTIONS, CORE DESCRIPTIONS, FIRE-RESISTANCE RATING, TEMPERATURE-RISE RATINGS, AND FINISHES.

SHOP DRAWINGS: INCLUDE THE FOLLOWING:

- **ELEVATIONS OF EACH DOOR DESIGN** DETAILS OF DOORS, INCLUDING VERTICAL AND HORIZONTAL EDGE DETAILS AND METAL THICKNESSES. FRAME DETAILS FOR EACH FRAME TYPE, INCLUDING
- DIMENSIONED PROFILES AND METAL THICKNESSES. LOCATIONS OF REINFORCEMENT AND PREPARATIONS FOR
- DETAILS OF ACCESSORIES.
- DETAILS OF MOLDINGS, REMOVABLE STOPS, AND GLAZING. STANDARD DOUBLE ACTING SWING DOORS GENERAL: PROVIDE DOORS OF DESIGN INDICATED, NOT LESS THAN
 - THICKNESS INDICATED; FABRICATED WITH SMOOTH SURFACES, WITHOUT VISIBLE JOINTS OR SEAMS ON EXPOSED FACES UNLESS OTHERWISE INDICATED. COMPLY WITH ANSI/SDI A250.8. DESIGN: AS INDICATED.
 - CORE CONSTRUCTION: 3/4 INCH (19 MM) EXTERIOR GRADE SOLID WOOD CORE MADE WITH ADHESIVES AND COMPOSITE WOOD PRODUCTS THAT DO NOT CONTAIN UREA FORMALDEHYDE
 - VERTICAL EDGES FOR DOUBLE-ACTING DOORS: ROUND VERTICAL EDGES WITH 2-1/8 INCH (54 MM) RADIUS. TOP AND BOTTOM EDGES: CLOSED WITH FLUSH OR INVERTED 0.042 INCH (1.0 MM) THICK, END CLOSURES OR CHANNELS OF
 - SAME MATERIAL AS FACE SHEETS. TOLERANCES: COMPLY WITH SDI 117, "MANUFACTURING TOLERANCES FOR STANDARD STEEL DOORS AND FRAMES." INTERIOR DOORS: FACE SHEETS FABRICATED FROM DECORATIVE HIGH
 - PRESSURE LAMINATE. PROVIDE DOORS COMPLYING WITH REQUIREMENTS INDICATED BELOW BY REFERENCING ANSI/SDI A250.8 FOR LEVEL AND MODEL AND ANSI/SDI A250.4 FOR PHYSICAL PERFORMANCE LEVEL:
 - LEVEL 1 AND PHYSICAL PERFORMANCE LEVEL C (STANDARD DUTY).
 - WIDTH: AS INDICATED ON DRAWINGS. HARDWARE REINFORCEMENT: FABRICATE ACCORDING TO ANSI/SDI A250.6 WITH REINFORCING PLATES OF 18 GAUGE STAINLESS
- FABRICATE CONCEALED STIFFENERS AND HARDWARE REINFORCEMENT FROM EITHER COLD- OR HOT-ROLLED STEEL SHEET.
- STOPS AND MOLDINGS
- MOLDINGS FOR GLAZED LITES IN DOORS:
- MINIMUM 0.032 INCH (0.8 MM) THICK. LOOSE STOPS FOR GLAZED LITES IN FRAMES:
- MINIMUM 0.032 INCH (0.8 MM) THICK, FABRICATED FROM SAME MATERIAL AS FRAMES IN WHICH THEY ARE INSTALLED. STEEL FINISHES
- PRIME FINISH: APPLY MANUFACTURER'S STANDARD PRIMER
 - IMMEDIATELY AFTER CLEANING AND PRETREATING. SHOP PRIMER: MANUFACTURER'S STANDARD, FAST-CURING, LEAD- AND CHROMATE-FREE PRIMER COMPLYING WITH ANSI/SDI A250.10 ACCEPTANCE CRITERIA; RECOMMENDED BY PRIMER MANUFACTURER FOR SUBSTRATE; COMPATIBLE WITH

COMPLYING WITH ANSI/SDI A250.3 FOR PERFORMANCE AND

SUBSTRATE AND FIELD-APPLIED COATINGS DESPITE PROLONGED EXPOSURE. FACTORY-APPLIED PAINT FINISH: MANUFACTURER'S STANDARD

ACCEPTANCE CRITERIA. 1.6 COLOR AND GLOSS: AS INDICATED BY MANUFACTURER'S DESIGNATIONS.

SECTION 09216 - NON-LOAD-BEARING STEEL FRAMING

FINISHES

- NON-LOAD-BEARING STEEL FRAMING MEMBERS FOR INTERIOR FRAMING
- MATERIALS 1.2 STEEL FRAMING FOR FRAMED ASSEMBLIES: FRAMING MEMBERS, GENERAL: COMPLY WITH ASTM C 754 FOR CONDITIONS
 - STEEL SHEET COMPONENTS: COMPLY WITH ASTM C 645 REQUIREMENTS FOR METAL, UNLESS OTHERWISE INDICATED.
- PROTECTIVE COATING: COATING WITH EQUIVALENT CORROSION RESISTANCE OF ASTM A 653/A 653M, G40 (Z120), HOT-DIP GALVANIZED, UNLESS OTHERWISE INDICATED
- STEEL FRAMING FOR FRAMED ASSEMBLIES SALVAGED MATERIAL: USE SALVAGED FRAMING MATERIALS WHENEVER
- **AVAILABLE** STEEL STUDS AND RUNNERS: ASTM C 645.
- MINIMUM BASE-METAL THICKNESS: 0.033 INCH (0.84 MM) UNLESS OTHERWISE INDICATED ON DRAWINGS. DEPTH: AS INDICATED ON DRAWINGS.
- DIMPLED STEEL STUDS AND RUNNERS: MINIMUM BASE-METAL THICKNESS: 0.025 INCH (0.64 MM). DEPTH: AS INDICATED ON DRAWINGS.
- SLIP-TYPE HEAD JOINTS: WHERE INDICATED, PROVIDE ONE OF THE FOLLOWING: SINGLE LONG-LEG RUNNER SYSTEM: ASTM C 645 TOP RUNNER
 - WITH 2 INCH (50.8 MM) DEEP FLANGES IN THICKNESS NOT LESS THAN INDICATED FOR STUDS, INSTALLED WITH STUDS FRICTION FIT INTO TOP RUNNER AND WITH CONTINUOUS BRIDGING LOCATED WITHIN 12 INCHES (305 MM) OF THE TOP OF STUDS TO PROVIDE LATERAL BRACING.
- DOUBLE-RUNNER SYSTEM: ASTM C 645 TOP RUNNERS, INSIDE RUNNER WITH 2 INCH (50.8 MM) DEEP FLANGES IN THICKNESS NOT LESS THAN INDICATED FOR STUDS AND FASTENED TO STUDS, AND OUTER RUNNER SIZED TO FRICTION FIT INSIDE RUNNER
- DEFLECTION TRACK: STEEL SHEET TOP RUNNER MANUFACTURED TO PREVENT CRACKING OF FINISHES APPLIED TO INTERIOR PARTITION FRAMING RESULTING FROM DEFLECTION OF STRUCTURE ABOVE: IN THICKNESS NOT LESS THAN INDICATED FOR STUDS AND IN WIDTH TO ACCOMMODATE DEPTH OF STUDS.
- COLD-ROLLED CHANNEL BRIDGING: 0.0538 INCH (1.37 MM) BARE-STEEL THICKNESS, WITH MINIMUM 1/2 INCH (12.7 MM) WIDE FLANGES. DEPTH: 1-1/2 INCHES (38.1 MM) CLIP ANGLE: NOT LESS THAN 1-1/2 BY 1-1/2 INCHES (38.1 BY
- 38.1 MM), 0.068 INCH (1.73 MM) THICK, GALVANIZED STEEL. HAT-SHAPED, RIGID FURRING CHANNELS: ASTM C 645. MINIMUM BASE METAL THICKNESS: AS INDICATED ON DRAWINGS DEPTH: AS INDICATED ON DRAWINGS.
- COLD-ROLLED FURRING CHANNELS: 0.0538 INCH (1.37 MM) BARE-STEEL THICKNESS, WITH MINIMUM 1/2 INCH (12.7 MM) WIDE FLANGES. DEPTH: AS INDICATED ON DRAWINGS. FURRING BRACKETS: ADJUSTABLE, CORRUGATED-EDGE TYPE OF
 - STEEL SHEET WITH MINIMUM BARE-STEEL THICKNESS OF 0.0312 INCH (0.79 MM). TIE WIRE: ASTM A 641/A 641M, CLASS 1 ZINC COATING, SOFT TEMPER, 0.0625 INCH (1.59 MM) DIAMETER WIRE, OR DOUBLE
- STRAND OF 0.0475 INCH (1.21 MM) DIAMETER WIRE. Z-SHAPED FURRING: WITH SLOTTED OR NONSLOTTED WEB, FACE FLANGE OF 1-1/4 INCHES (31.8 MM), WALL ATTACHMENT FLANGE OF 7/8 INCH (22.2 MM), MINIMUM BARE-METAL THICKNESS OF 0.0179 INCH (0.45 MM), AND

DEPTH REQUIRED TO FIT INSULATION THICKNESS INDICATED **END OF SECTION 09216**

SECTION 092900 - GYPSUM BOARD

- INTERIOR GYPSUM BOARD.
- TILE BACKING PANELS. 1.2 SUBMITTALS
 - PRODUCT DATA: FOR EACH TYPE OF PRODUCT INDICATED SAMPLES: FOR THE FOLLOWING PRODUCTS: TEXTURED FINISHES: MANUFACTURER'S STANDARD SIZE FOR EACH TEXTURED FINISH INDICATED AND ON SAME BACKING INDICATED
- FOR WORK MATERIALS 1.3
 - GENERAL: COMPLYING WITH ASTM C 36/C 36M OR ASTM C 1396/C 1396M, AS APPLICABLE TO TYPE OF GYPSUM BOARD INDICATED AND WHICHEVER IS MORE STRINGENT.
 - MUST BE CERTIFIED AS LOW EMITTING. CERTIFICATION MUST BE BASED UPON THE CALIFORNIA DEPARTMENT OF HEALTH SERVICES' "STANDARD PRACTICE FOR THE TESTING OF VOLATILE ORGANIC EMISSIONS FROM VARIOUS SOURCES USING SMALL-SCALE ENVIRONMENTAL CHAMBERS", INCLUDING 2004 ADDENDA OR A
 - JURISDICTIONALLY RECOGNIZED STANDARD USING VALENT TESTING METHODOLOGIES AND VOC THRESHOLDS.
 - THICKNESS: 5/8 INCH (15.9 MM). LONG EDGES: TAPERED. MOISTURE- AND MOLD-RESISTANT TYPE: WITH MOISTURE- AND MOLD-RESISTANT CORE AND SURFACES.
 - CORE: 5/8 INCH (15.9 MM), TYPE X. LONG EDGES: TAPERED. MOLD RESISTANCE: ASTM D 3273, SCORE OF 10 AS RATED ACCORDING TO ASTM D 3274
 - TILE-BACKING PANELS: GLASS-MAT. WATER-RESISTANT BACKING BOARD: ASTM C 1178/C 1178M. WITH MANUFACTURER'S STANDARD EDGES. MUST BE CERTIFIED AS LOW EMITTING. CERTIFICATION MUST BE BASED UPON THE CALIFORNIA DEPARTMENT OF HEALTH SERVICES' "STANDARD PRACTICE FOR THE TESTING OF VOLATILE ORGANIC EMISSIONS FROM VARIOUS SOURCES USING SMALL-SCALE ENVIRONMENTAL
 - CHAMBERS", INCLUDING 2004 ADDENDA OR A JURISDICTIONALLY RECOGNIZED STANDARD USING EQUIVALENT TESTING METHODOLOGIES AND VOC THRESHOLDS.
 - CORE: 5/8 INCH (15.9 MM), TYPE X. MOLD RESISTANCE: ASTM D 3273, SCORE OF 10 AS RATED ACCORDING TO ASTM D 3274 CEMENTITIOUS BACKER UNITS: ANSI A118.9 AND ASTM C 1288 OR 1325, WITH MANUFACTURER'S STANDARD EDGES.
 - THICKNESS: [1/4 INCH (6.4 MM)] [AS INDICATED]. MOLD RESISTANCE: ASTM D 3273, SCORE OF 10 AS RATED ACCORDING TO ASTM D 3274.

TRIM ACCESSORIES: a. INTERIOR: CORNERBEAD.

END OF SECTION 092900

FINISHES (CONTINUED)

SECTION 093000 - CERAMIC TILE

- PAVER, GLAZED, AND WALL TILE.
- WATERPROOF MEMBRANE FOR THIN-SET TILE INSTALLATIONS. METAL EDGE STRIPS INSTALLED AS PART OF TILE INSTALLATIONS.
- QUALITY ASSURANCE MOCKUPS FOR EACH FORM OF CONSTRUCTION.
- GLAZED WALL TILE TRIM SHAPES: COVED BASE, BULLNOSE CAP. THRESHOLDS: SATIN ANODIZED ALUMINUM THRESHOLDS AND TRANSITION
- BEVEL EDGES AT 1:2 SLOPE, WITH LOWER EDGE OF BEVEL ALIGNED WITH OR UP TO 1/16 INCH (1.5 MM) ABOVE ADJACENT FLOOR SURFACE. FINISH BEVEL TO MATCH TOP SURFACE OF THRESHOLD. LIMIT HEIGHT OF THRESHOLD TO 1/2 INCH (12.7 MM) OR LESS ABOVE ADJACENT FLOOR SURFACE.
- MORTAR: LATEX-PORTLAND CEMENT ELASTOMERIC SEALANTS: ONE-PART, MILDEW-RESISTANT SILICONE. SEALANTS SHALL HAVE A VOC CONTENT OF [250] <INSERT VALUE> G/L OR LESS WHEN CALCULATED ACCORDING TO 40 CFR 59.
- SUBPART D (EPA METHOD 24).
- 1.4 FLOOR TILE INSTALLATION SCHEDULE INTERIOR FLOORS ON CONCRETE: THIN-SET MORTAR.
 - TILE TYPE: UNGLAZED PAVER TILE. MORTAR: LATEX- PORTLAND CEMENT MORTAR BOND COAT.
- GROUT: POLYMER-MODIFIED UNSANDED 100% SOLIDS EPOXY NON-SAGGING GROUT INTERIOR FLOORS ON [WATERPROOF] [CRACK-SUPPRESSION] MEMBRANE
- OVER CONCRETE AND WOOD: THIN-SET MORTAR TILE TYPE: UNGLAZED PAVER TILE. MORTAR: LATEX-PORTLAND CEMENT MORTAR BOND COAT.

GROUT: POLYMER-MODIFIED UNSANDED 100% SOLIDS EPOXY

- NON-SAGGING GROUT. 1.5 WALL TILE INSTALLATION SCHEDULE INTERIOR WALLS OVER GLASS-MAT WATER-RESISTANT BACKER BOARD OR
- CEMENTITIOUS BACKER UNITS: THIN-SET MORTAR. TILE TYPE: [UNGLAZED CERAMIC MOSAIC] [GLAZED CERAMIC MOSAIC] [GLAZED WALL] TILE.
- MORTAR: LATEX- PORTLAND CEMENT MORTAR. GROUT: POLYMER-MODIFIED UNSANDED GROUT **END OF SECTION 093000**

SECTION 095113 - ACOUSTICAL PANEL CEILINGS

- SUMMARY ACOUSTICAL PANELS AND EXPOSED SUSPENSION SYSTEMS.
- SUBMITTALS PRODUCT DATA: FOR EACH TYPE OF PRODUCT INDICATED COORDINATION DRAWINGS: REFLECTED CEILING PLANS, DRAWN TO SCALE, ON WHICH THE FOLLOWING ITEMS ARE SHOWN AND COORDINATED WITH EACH OTHER, BASED ON INPUT FROM INSTALLERS OF THE ITEMS
 - CEILING SUSPENSION SYSTEM MEMBERS.
 - METHOD OF ATTACHING HANGERS TO BUILDING STRUCTURE. CEILING-MOUNTED ITEMS INCLUDING LIGHTING FIXTURES, DIFFUSERS, GRILLES, SPEAKERS, SPRINKLERS, ACCESS PANELS
- AND SPECIAL MOLDINGS. SAMPLES FOR VERIFICATION: FOR EACH COMPONENT INDICATED AND FOR EACH EXPOSED FINISH REQUIRED, PREPARED ON SAMPLES OF SIZE
- INDICATED BELOW. ACOUSTICAL PANEL: SET OF FULL-SIZE SAMPLES OF EACH TYPE, COLOR, PATTERN, AND TEXTURE.
- EXPOSED SUSPENSION SYSTEM MEMBERS, MOLDINGS, AND TRIM: SET OF 12 INCH (300 MM) LONG SAMPLES OF EACH TYPE, FINISH,
- AND COLOR. QUALIFICATION DATA: FOR TESTING AGENCY.
- FIELD QUALITY-CONTROL TEST REPORTS. PRODUCT TEST REPORTS: BASED ON EVALUATION OF COMPREHENSIVE TESTS PERFORMED BY A QUALIFIED TESTING AGENCY, FOR EACH
- ACOUSTICAL PANEL CEILING. MAINTENANCE DATA: FOR FINISHES TO INCLUDE IN MAINTENANCE
- MANUALS. QUALITY ASSURANCE ACOUSTICAL PANEL QUALITY STANDARD: ASTM E 1264.
- METAL SUSPENSION SYSTEM QUALITY STANDARD: ASTM C 635. ACOUSTICAL CEILING PANELS GENERAL: MUST BE CERTIFIED AS LOW EMITTING. CERTIFICATION MUST BE BASED UPON THE CALIFORNIA DEPARTMENT OF HEALTH SERVICES' "STANDARD PRACTICE FOR THE
- SMALL-SCALE ENVIRONMENTAL CHAMBERS", INCLUDING 2004 ADDENDA OR A JURISDICTIONALLY RECOGNIZED STANDARD USING EQUIVALENT TESTING METHODOLOGIES AND VOC THRESHOLDS. ACOUSTICAL CEILING PANELS WASHABLE

TESTING OF VOLATILE ORGANIC EMISSIONS FROM VARIOUS SOURCES USING

- CLASSIFICATION: TYPE IV, MINERAL BASE WITH MEMBRANE-FACED OVERLAY; FORM 2, WATER FELTED; WITH VINYL OVERLAY ON FACE; PATTERN G (SMOOTH).
- COLOR: AS INDICATED ON DRAWINGS.
- THICKNESS: 5/8 INCH (15 MM) MODULAR SIZE: 24 BY 48 INCHES (610 BY 1220 MM). BROAD SPECTRUM ANTIMICROBIAL FUNGICIDE AND BACTERICIDE TREATMENT: PROVIDE ACOUSTICAL TILES TREATED WITH MANUFACTURER'S STANDARD ANTIMICROBIAL FORMULATION THAT INHIBITS FUNGUS, MOLD, MILDEW, AND GRAM-POSITIVE AND
- GRAM-NEGATIVE BACTERIA AND SHOWING NO MOLD, MILDEW, OR BACTERIAL GROWTH WHEN TESTED ACCORDING TO ASTM D 3273 AND EVALUATED ACCORDING TO ASTM D 3274 OR ASTM G 21.
- ACOUSTICAL CEILING PANELS TEXTURED: CLASSIFICATION: TYPE III, MINERAL BASE WITH PAINTED FINISH; FORM 2, WATER FELTED; PATTERN E (LIGHTLY TEXTURED).
- THICKNESS: 5/8 INCH (15 MM) MODULAR SIZE: 24 BY 48 INCHES (610 BY 1220 MM). BROAD SPECTRUM ANTIMICROBIAL FUNGICIDE AND BACTERICIDE TREATMENT: PROVIDE ACOUSTICAL TILES TREATED WITH MANUFACTURER'S STANDARD ANTIMICROBIAL FORMULATION THAT INHIBITS FUNGUS, MOLD, MILDEW, AND GRAM-POSITIVE AND

GRAM-NEGATIVE BACTERIA AND SHOWING NO MOLD, MILDEW, OR

BACTERIAL GROWTH WHEN TESTED ACCORDING TO ASTM D 3273 AND EVALUATED ACCORDING TO ASTM D 3274 OR ASTM G 21. ACOUSTICAL CEILING PANELS PERFORATED: CLASSIFICATION: TYPE III, MINERAL BASE WITH PAINTED FINISH;

COLOR: AS INDICATED ON DRAWINGS.

- FORM 2, WATER FELTED; PATTERN CE (PERFORATED, SMALL
 - HOLES AND LIGHTLY TEXTURED). COLOR: AS INDICATED ON DRAWINGS. THICKNESS: 3/4 INCH (15 MM) MODULAR SIZE: 24 BY 48 INCHES (610 BY 1220 MM).
- BROAD SPECTRUM ANTIMICROBIAL FUNGICIDE AND BACTERICIDE TREATMENT: PROVIDE ACOUSTICAL TILES TREATED WITH MANUFACTURER'S STANDARD ANTIMICROBIAL FORMULATION THAT INHIBITS FUNGUS, MOLD, MILDEW, AND GRAM-POSITIVE AND GRAM-NEGATIVE BACTERIA AND SHOWING NO MOLD, MILDEW, OR BACTERIAL GROWTH WHEN TESTED ACCORDING TO ASTM D 3273
- AND EVALUATED ACCORDING TO ASTM D 3274 OR ASTM G 21. METAL SUSPENSION SYSTEMS: WIDE-FACE, CAPPED, DOUBLE-WEB STEEL: INTERMEDIATE DUTY. METAL EDGE MOLDINGS AND TRIM: ROLL-FORMED SHEET METAL.
- INSTALLATION A. INSTALLATION: [ASTM C 636] [UBC STANDARD 25-2]. FIELD QUALITY CONTROL TESTING: BY [OWNER] [CONTRACTOR]-ENGAGED AGENCY TO TEST

ACOUSTICAL PANEL CEILING HANGER FASTENERS.

END OF SECTION 095113

Sheet Title:

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Architect of Record

SALASOBRIEN

5 South 11th Street



Revision Schedule Description

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HUMAYDAN

A. HUMAYDEN

Store #: 20170 | Project # 55066-003 MCS Concept: Palette: Issue Date: 4/10/14 **ANDREW** Design Manager:

Checked by:

Scale:

Production Designer

LEED® AP:

DESIGN **SPECIFICATIONS**

Sheet Number:

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FINISHES (CONTINUED)
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SECTION 09930 - WOOD STAINS AND TRANSPARENT FINISHES
1.1 SUMMARY
            SURFACE PREPARATION AND APPLICATION OF WOOD FINISHES ON
             [EXTERIOR] [AND] [INTERIOR] SUBSTRATES.
     SUBMITTALS
            SAMPLES FOR VERIFICATION: FOR EACH TYPE OF FINISH SYSTEM AND IN
             EACH COLOR AND GLOSS OF FINISH INDICATED.
1.3 QUALITY ASSURANCE
            QUALITY STANDARDS: "MPI APPROVED PRODUCTS LIST" AND "MPI
             ARCHITECTURAL PAINTING SPECIFICATION MANUAL."
            CHEMICAL COMPONENTS OF FIELD-APPLIED INTERIOR PAINTS AND COATINGS:
                  VOC LIMITS:
                        CLEAR WOOD FINISHES, VARNISHES: VOC NOT MORE THAN
                          350 G/L.
                         SHELLACS, CLEAR: VOC NOT MORE THAN 730 G/L.
                         STAINS: VOC NOT MORE THAN 250 G/L.
                         PRIMERS, SEALERS, AND UNDERCOATERS: 200 G/L.
                         FIRE RETARDANT COATINGS, CLEAR: 650 G/L.
                        FIRE RETARDANT COATINGS, PIGMENTED: 350 G/L.
1.5 EXTERIOR WOOD-FINISH-SYSTEM SCHEDULE
            SOLID-COLOR LATEX STAIN SYSTEM: MPI EXT 6.3K.
                  PRIME COAT: PRIMER, LATEX FOR EXTERIOR WOOD.
                   INTERMEDIATE COAT: STAIN, EXTERIOR, WATER BASED, SOLID HIDE,
                   MATCHING TOPCOAT.
                   TOPCOAT: STAIN, EXTERIOR, WATER BASED, SOLID HIDE.
            SEMITRANSPARENT STAIN SYSTEM: MPI EXT 6.3D.
             1. TWO STAIN COATS: EXTERIOR SEMITRANSPARENT LATEX STAIN.
1.6 INTERIOR WOOD-FINISH-SYSTEM SCHEDULE
            SEMITRANSPARENT STAIN SYSTEM:
                  PRIME COAT: STAIN, SEMI-TRANSPARENT, MATCHING TOPCOAT.
                  TOPCOAT: STAIN, SEMI-TRANSPARENT, FOR INTERIOR WOOD.
           WATER-BASED VARNISH SYSTEM:
                  PRIME COAT: WATER-BASED VARNISH MATCHING TOPCOAT.
                  INTERMEDIATE COAT: WATER-BASED VARNISH MATCHING TOPCOAT.
                  TOPCOAT: VARNISH, WATER BASED, CLEAR.
           WATER-BASED FIRE RETARDANT SYSTEM:
                  TOPCOAT: FIRE RETARDANT COATING, CLEAR.
                         CLASS A FLAME SPREAD AND SMOKE-DEVELOPED INDEX PER
                          ASTM E 84.
END OF SECTION 09930
```

SECTION 097200 - WALL COVERINGS SUMMARY A. VINYL AND WOVEN GLASS-FIBER WALL COVERING. 1.2 MATERIALS ADHESIVE: MILDEW-RESISTANT, NONSTAINING, STRIPPABLE ADHESIVE, FOR USE WITH SPECIFIC WALL COVERING AND SUBSTRATE APPLICATION, AS RECOMMENDED IN WRITING BY WALL-COVERING MANUFACTURER, AND WITH A VOC CONTENT OF 50 G/L OR LESS WHEN CALCULATED ACCORDING TO 40 CFR 59, SUBPART D (EPA METHOD 24). 1.3 INSTALLATION

A. INSTALL STRIPS IN SAME ORDER AS CUT FROM ROLL. END OF SECTION 097200

SECTION 099123 - INTERIOR PAINTING

SURFACE PREPARATION AND THE APPLICATION OF PAINT SYSTEMS ON INTERIOR SUBSTRATES. 1.2 SUBMITTALS A. SAMPLES FOR VERIFICATION: FOR EACH NON-STANDARD LATEX TOPCOAT COLOR AND GLOSS INDICATED.

FOR EACH TYPE OF NON-STANDARD PAINT SYSTEM AND IN EACH COLOR AND GLOSS OF TOPCOAT INDICATED. QUALITY ASSURANCE

QUALITY STANDARDS: "MPI APPROVED PRODUCTS LIST" AND "MPI ARCHITECTURAL PAINTING SPECIFICATION MANUAL."

MOCKUPS FOR EACH COLOR AND FINISH.

GENERAL VOC CONTENT: PRODUCTS SHALL COMPLY WITH VOC LIMITS OF AUTHORITIES HAVING JURISDICTION [AND, FOR INTERIOR PAINTS AND COATINGS APPLIED AT PROJECT SITE, THE FOLLOWING VOC LIMITS,

EXCLUSIVE OF COLORANTS ADDED TO A TINT BASE, WHEN CALCULATED ACCORDING TO 40 CFR 59, SUBPART D (EPA METHOD 24)]. FLAT PAINTS AND COATINGS: 50 G/L. NONFLAT PAINTS AND COATINGS: 150 G/L. DRY-FOG COATINGS: 400 G/L. PRIMERS, SEALERS, AND UNDERCOATERS: 200 G/L. ANTICORROSIVE AND ANTIRUST PAINTS APPLIED TO FERROUS METALS: 250 G/L.

ZINC-RICH INDUSTRIAL MAINTENANCE PRIMERS: 340 G/L. PRETREATMENT WASH PRIMERS: 420 G/L.

FLOOR COATINGS: 100 G/L. SHELLACS, CLEAR: 730 G/L.

SHELLACS, PIGMENTED: 550 G/L. 1.5 INTERIOR PAINTING SCHEDULE

STEEL SUBSTRATES:

INSTITUTIONAL LOW-ODOR/VOC LATEX SYSTEM: PRIME COAT: PRIMER, RUST-INHIBITIVE, WATER BASED. TOPCOAT: INSTITUTIONAL LOW-ODOR/VOC INTERIOR

LATEX (GLOSS LEVEL AS INDICATED IN PAINT SCHEDULE). GALVANIZED-METAL SUBSTRATES: 1. INSTITUTIONAL LOW-ODOR/VOC LATEX SYSTEM:

PRIME COAT: PRIMER, GALVANIZED, WATER BASED. TOPCOAT: LATEX, INTERIOR, INSTITUTIONAL LOW ODOR/VOC, (GLOSS LEVEL AS INDICATED IN PAINT

WOOD SUBSTRATES:

INSTITUTIONAL LOW-ODOR/VOC LATEX SYSTEM: PRIME COAT: INTERIOR LATEX PRIMER/SEALER.

TOPCOAT: INSTITUTIONAL LOW-ODOR/VOC INTERIOR LATEX (GLOSS LEVEL AS INDICATED IN PAINT SCHEDULE). GYPSUM BOARD SUBSTRATES: 1. INSTITUTIONAL LOW-ODOR/VOC LATEX SYSTEM:

PRIME COAT: INTERIOR LATEX PRIMER/SEALER. TOPCOAT: INSTITUTIONAL LOW-ODOR/VOC INTERIOR

LATEX (GLOSS LEVEL AS INDICATED IN PAINT SCHEDULE). HIGH-IMPACT GYPSUM BOARD SUBSTRATES: 1. HIGH-PERFORMANCE ARCHITECTURAL LATEX SYSTEM:

PRIME COAT: INTERIOR LATEX PRIMER/SEALER.

TOPCOAT: INSTITUTIONAL LOW-ODOR/VOC INTERIOR LATEX (GLOSS LEVEL AS INDICATED IN PAINT SCHEDULE). PLASTER SUBSTRATES:

INSTITUTIONAL LOW-ODOR/VOC LATEX SYSTEM: PRIME COAT: INTERIOR LATEX PRIMER/SEALER.

TOPCOAT: INSTITUTIONAL LOW-ODOR/VOC INTERIOR LATEX (GLOSS LEVEL AS INDICATED IN PAINT SCHEDULE). ACOUSTICAL CEILING TILE:

1. INSTITUTIONAL LOW-ODOR/VOC LATEX SYSTEM: PRIME COAT: INTERIOR LATEX PRIMER/SEALER.

TOPCOAT: INSTITUTIONAL LOW-ODOR/VOC INTERIOR LATEX (GLOSS LEVEL AS INDICATED IN PAINT SCHEDULE). END OF SECTION 099123



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Architect of Record



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Store #: Project #: 55066-003 MCS Concept: Palette:

4/10/14

HUMAYDAN

A. HUMAYDEN

Issue Date: Design Manager: LEED®AP:

Production Designer:

Checked by:

Sheet Title:

DESIGN SPECIFICATIONS

Sheet Number:

CODE REQUIREMENTS (2013 CBC)

ENTRANCES, DOORS AND DOORWAYS

11B-404.2.11 VISION LIGHTS. DOORS, GATES, AND SIDE LIGHTS ADJACENT TO DOORS OR GATES, CONTAINING ONE OR MORE GLAZING PANELS THAT PERMIT VIEWING THROUGH THE PANELS SHALL HAVE THE BOTTOM OF AT LEAST ONE GLAZED PANEL LOCATED 43 INCHES (1092 MM) MAXIMUM ABOVE THE FINISH FLOOR.

11B-404.2.7 DOOR AND GATE HARDWARE, HANDLES, PULLS, LATCHES, LOCKS, AND OTHER OPERABLE PARTS ON DOORS AND GATES SHALL COMPLY WITH SECTION 11B-309.4. OPERABLE PARTS OF SUCH HARDWARE SHALL BE 34 INCHES (864 MM) MINIMUM AND 44 INCHES (1118 MM) MAXIMUM ABOVE THE FINISH FLOOR OR GROUND. WHERE SLIDING DOORS ARE IN THE FULLY OPEN POSITION, OPERATING HARDWARE SHALL BE EXPOSED AND USABLE FROM BOTH SIDES.

11B-404.2.9 DOOR AND GATE OPENING FORCE. THE FORCE FOR PUSHING OR PULLING OPEN A DOOR OR GATE OTHER THAN FIRE DOORS SHALL BE AS FOLLOWS: 1. INTERIOR HINGED DOORS AND GATES: 5 POUNDS (22.2 N) MAXIMUM. 2. EXTERIOR HINGED DOORS: 5 POUNDS (22.2 N) MAXIMUM.

11B-404.2.10 DOOR AND GATE SURFACES. SWINGING DOOR AND GATE SURFACES WITHIN 11B-309.4 OPERATION. OPERABLE PARTS SHALL BE OPERABLE WITH ONE HAND AND 10 INCHES (254 MM) OF THE FINISH FLOOR OR GROUND MEASURED VERTICALLY SHALL HAVE A SMOOTH SURFACE ON THE PUSH SIDE EXTENDING THE FULL WIDTH OF THE DOOR OR GATE.

ALL REQUIRED EXIT DOORWAYS SHALL HAVE A MINIMUM 32" CLEAR OPENING WITH THE DOOR AT 90 DEGREES TO THE CLOSED POSITION. 1005.1, 1008.1.1

ONE DOOR OF A PAIR OF DOORS SHALL MEET THE MINIMUM WIDTH REQUIREMENTS.

11B-404.2.5 THRESHOLDS. THRESHOLDS. IF PROVIDED AT DOORWAYS. SHALL BE 1/2 INCH (12.7 MM) HIGH MAXIMUM. RAISED THRESHOLDS AND CHANGES IN LEVEL AT DOORWAYS SHALL COMPLY WITH SECTIONS 11B-302 AND 11B-303.

WATER CLOSETS

WHERE A TOILET STALL IS PROVIDED, IT SHALL COMPLY WITH SECTION 1127A.2.1 OR 1127A.2.2, AND ITS WATER CLOSET SHALL COMPLY WITH SECTION 1127A.2.3. 11B-604 WATER CLOSETS AND TOILET COMPARTMENTS

11B-604.1 GENERAL. WATER CLOSETS AND TOILET COMPARTMENTS SHALL COMPLY WIT SECTIONS 11B-604.2 THROUGH 11B-604.8.

11B-604.2 LOCATION. THE WATER CLOSET SHALL BE POSITIONED WITH A WALL OR PARTITION TO THE REAR AND TO ONE SIDE. THE CENTERLINE OF THE WATER CLOSET SHALL BE 17 INCHES (432 MM) MINIMUM TO 18 INCHES (457 MM) MAXIMUM FROM THE SIDE WALL OR PARTITION, EXCEPT THAT THE WATER CLOSET SHALL BE 17 INCHES (432 MM) MINIMUM AND 19 INCHES (483 MM) MAXIMUM FROM THE SIDE WALL OR PARTITION IN THE AMBULATORY ACCESSIBLE TOILET COMPARTMENT SPECIFIED IN SECTION 11B-604.8.2. WATER CLOSETS SHALL BE ARRANGED FOR A LEFT-HAND OR RIGHT-HAND APPROACH.

11B-604.3 CLEARANCE. CLEARANCES AROUND WATER CLOSETS AND IN TOILET COMPARTMENTS SHALL COMPLY WITH SECTION 11B-604.3.

11B-604.3.1 SIZE. CLEARANCE AROUND A WATER CLOSET SHALL BE 60 INCHES (1524 MM) MINIMUM MEASURED PERPENDICULAR FROM THE SIDE WALL AND 56 INCHES (1422 MM) MINIMUM MEASURED PERPENDICULAR FROM THE REAR WALL. A MINIMUM 60 INCHES (1524) MM) WIDE AND 48 INCHES (1219 MM) DEEP MANEUVERING SPACE SHALL BE PROVIDED IN 11B-306.3.2 MAXIMUM DEPTH. KNEE CLEARANCE SHALL EXTEND 25 INCHES (635 MM) FRONT OF THE WATER CLOSET.

11B-604.3.2 OVERLAP. THE REQUIRED CLEARANCE AROUND THE WATER CLOSET SHALL BE PERMITTED TO OVERLAP THE WATER CLOSET, ASSOCIATED GRAB BARS. DISPENSERS, SANITARY NAPKIN DISPOSAL UNITS, COAT HOOKS, SHELVES, ACCESSIBLE ROUTES, CLEAR FLOOR SPACE AND CLEARANCES REQUIRED AT OTHER FIXTURES, AND THE TURNING SPACE. NO OTHER FIXTURES OR OBSTRUCTIONS SHALL BE LOCATED WITHIN THE REQUIRED WATER CLOSET CLEARANCE.

11B-604.4 SEATS. THE SEAT HEIGHT OF A WATER CLOSET ABOVE THE FINISH FLOOR SHALL BE 17 INCHES (432 MM) MINIMUM AND 19 INCHES (483 MM) MAXIMUM MEASURED TO 1. AT LAVATORIES REQUIRED TO BE ACCESSIBLE BY SECTION THE TOP OF THE SEAT. SEATS SHALL NOT BE SPRUNG TO RETURN TO A LIFTED POSITION. SEATS SHALL BE 2 INCHES (51 MM) HIGH MAXIMUM.

11B-604.6 FLUSH CONTROLS. FLUSH CONTROLS SHALL BE HAND OPERATED OR AUTOMATIC. HAND OPERATED FLUSH CONTROLS SHALL COMPLY WITH SECTION 11B-309 WALL-MOUNTED LAVATORY FIXTURE. EXCEPT THEY SHALL BE LOCATED 44 INCHES (1118 MM) MAXIMUM ABOVE THE FLOOR. FLUSH CONTROLS SHALL BE LOCATED ON THE OPEN SIDE OF THE WATER CLOSET EXCEPT IN AMBULATORY ACCESSIBLE COMPARTMENTS COMPLYING WITH SECTION 11B604.8.2.

GRAB BARS

GRAB BARS FOR WATER CLOSETS SHALL COMPLY WITH SECTION 11B-609. GRAB BARS SHALL BE PROVIDED ON THE SIDE WALL CLOSEST TO THE WATER CLOSET AND ON THE REAR WALL

11B-604.5.1 SIDE WALL. THE SIDE WALL GRAB BAR SHALL BE 42 INCHES (1067 MM) LONG MINIMUM, LOCATED 12 INCHES (305 MM) MAXIMUM FROM THE REAR WALL AND EXTENDING LAVATORIES OR COUNTERTOPS SHALL BE INSTALLED WITH THE BOTTOM EDGE OF THE 54 INCHES (1372 MM) MINIMUM FROM THE REAR WALL WITH THE FRONT END POSITIONED 24 INCHES (610 MM) MINIMUM IN FRONT OF THE WATER CLOSET.

11B-604.5.2 REAR WALL. THE REAR WALL GRAB BAR SHALL BE 36 INCHES (914 MM) LONG MINIMUM AND EXTEND FROM THE CENTERLINE OF THE WATER CLOSET 12 INCHES (305 MM) MINIMUM ON ONE SIDE AND 24 INCHES (610 MM) MINIMUM ON THE OTHER SIDE.

11B-609.4 POSITION OF GRAB BARS. GRAB BARS SHALL BE INSTALLED IN A HORIZONTAL POSITION, 33 INCHES (838 MM) MINIMUM AND 36 INCHES (914 MM) MAXIMUM ABOVE THE FINISH FLOOR MEASURED TO THE TOP OF THE GRIPPING SURFACE, EXCEPT THAT AT WATER CLOSETS FOR CHILDREN'S USE COMPLYING WITH SECTION 11B-604.9, GRAB 27 INCHES (686 MM) MAXIMUM ABOVE THE FINISH FLOOR MEASURED TO THE TOP OF THE GRIPPING SURFACE.

11B-609.2.1 CIRCULAR CROSS SECTION. GRAB BARS WITH CIRCULAR CROSS SECTIONS SHALL HAVE AN OUTSIDE DIAMETER OF 1-1/4INCHES (32 MM) MINIMUM AND 2 INCHES (51

11B-609.3 SPACING. THE SPACE BETWEEN THE WALL AND THE GRAB BAR SHALL BE 1-1/2 INCHES (38 MM). THE SPACE BETWEEN THE GRAB BAR AND PROJECTING OBJECTS BELOW AND AT THE ENDS SHALL BE 1-1/2INCHES (38 MM) MINIMUM. THE SPACE BETWEEN THE GRAB BAR AND PROJECTING OBJECTS ABOVE SHALL BE 12 INCHES (305 MM)

11B-609.5 SURFACE HAZARDS. GRAB BARS AND ANY WALL OR OTHER SURFACES ADJACENT TO GRAB BARS SHALL BE FREE OF SHARP OR ABRASIVE ELEMENTS AND SHALL HAVE ROUNDED EDGES.

11B-609.6 FITTINGS. GRAB BARS SHALL NOT ROTATE WITHIN THEIR FITTINGS.11B-609.7 INSTALLATION. GRAB BARS SHALL BE INSTALLED IN ANY MANNER THAT PROVIDES A GRIPPING SURFACE AT THE SPECIFIED LOCATIONS AND THAT DOES NOT OBSTRUCT THE REQUIRED CLEAR FLOOR SPACE.

11B-609.8 STRUCTURAL STRENGTH. ALLOWABLE STRESSES SHALL NOT BE EXCEEDED FOR MATERIALS USED WHEN A VERTICAL OR HORIZONTAL FORCE OF 250 POUNDS (1112 N) IS APPLIED AT ANY POINT ON THE GRAB BAR, FASTENER, MOUNTING DEVICE, OR SUPPORTING STRUCTURE.

11B-609.9 ALTERNATE CONFIGURATION. L-SHAPED OR U-SHAPED GRAB BARS SHALL BE

ACCESSIBILITY NOTES

LAVATORIES AND SINKS

11B-213.3.4 LAVATORIES. WHERE LAVATORIES ARE PROVIDED, AT LEAST FIVE PERCENT BUT NO FEWER THAN ONE SHALL COMPLY WITH SECTION 11B-606 AND SHALL NOT BE LOCATED IN A TOILET COMPARTMENT.

11B-606.1 GENERAL. LAVATORIES AND SINKS SHALL COMPLY WITH SECTION 11B-606.

11B-606.2 CLEAR FLOOR SPACE. A CLEAR FLOOR SPACE COMPLYING WITH SECTION 11B-305, POSITIONED FOR A FORWARD APPROACH, AND KNEE AND TOE CLEARANCE

COMPLYING WITH SECTION 11B-306 SHALL BE PROVIDED. 11B-606.3 HEIGHT. LAVATORIES AND SINKS SHALL BE INSTALLED WITH THE FRONT OF THE

HIGHER OF THE RIM OR COUNTER SURFACE 34 INCHES (864 MM) MAXIMUM ABOVE THE FINISH FLOOR OR GROUND.

11B-606.4 FAUCETS. CONTROLS FOR FAUCETS SHALL COMPLY WITH SECTION 11B-309. HAND-OPERATED METERING FAUCETS SHALL REMAIN OPEN FOR 10 SECONDS MINIMUM.

SHALL NOT REQUIRE TIGHT GRASPING, PINCHING, OR TWISTING OF THE WRIST. THE

FORCE REQUIRED TO ACTIVATE OPERABLE PARTS SHALL BE 5 POUNDS (22.2 N) MAXIMUM. 11B-606.5 EXPOSED PIPES AND SURFACES. WATER SUPPLY AND DRAIN PIPES UNDER LAVATORIES AND SINKS SHALL BE INSULATED OR OTHERWISE CONFIGURED TO PROTECT

AGAINST CONTACT. THERE SHALL BE NO SHARP OR ABRASIVE SURFACES UNDER

LAVATORIES AND SINKS.

11B-306.2.1 GENERAL. SPACE UNDER AN ELEMENT BETWEEN THE FINISH FLOOR OR GROUND AND 9 INCHES (229 MM) ABOVE THE FINISH FLOOR OR GROUND SHALL BE CONSIDERED TOE CLEARANCE AND SHALL COMPLY WITH SECTION 11B-306.2.

11B-306.2.2 MAXIMUM DEPTH. TOE CLEARANCE SHALL EXTEND 25 INCHES (635 MM) MAXIMUM UNDER AN ELEMENT.

11B-306.2.3 MINIMUM REQUIRED DEPTH, WHERE TOE CLEARANCE IS REQUIRED AT AN ELEMENT AS PART OF A CLEAR FLOOR SPACE, THE TOE CLEARANCE SHALL EXTEND 17 INCHES (432 MM) MINIMUM UNDER THE ELEMENT.

11B-306.2.4 ADDITIONAL CLEARANCE. SPACE EXTENDING GREATER THAN 6 INCHES (152 MM) BEYOND THE AVAILABLE KNEE CLEARANCE AT 9 INCHES (229 MM) ABOVE THE FINISH FLOOR OR GROUND SHALL NOT BE CONSIDERED TOE CLEARANCE.

11B-306.2.5 WIDTH. TOE CLEARANCE SHALL BE 30 INCHES (762MM) WIDE MINIMUM.

KNEE CLEARANCE

11B-306.3.1 GENERAL. SPACE UNDER AN ELEMENT BETWEEN 9 INCHES (229 MM) AND 27 INCHES (686 MM) ABOVE THE FINISH FLOOR OR GROUND SHALL BE CONSIDERED KNEE CLEARANCE AND SHALL COMPLY WITH SECTION 11B-306.3. EXCEPTION: AT LAVATORIES REQUIRED TO BE ACCESSIBLE BY SECTION 11B-213.3.4, SPACE BETWEEN 9 INCHES (229 MM) AND 29 INCHES (737 MM) ABOVE THE FINISH FLOOR

MAXIMUM UNDER AN ELEMENT AT 9 INCHES (229 MM) ABOVE THE FINISH FLOOR OR

11B-306.3.3 MINIMUM REQUIRED DEPTH. WHERE KNEE CLEARANCE IS REQUIRED UNDER AN ELEMENT AS PART OF A CLEAR FLOOR SPACE, THE KNEE CLEARANCE SHALL BE 11 INCHES (279 MM) DEEP MINIMUM AT 9 INCHES (229 MM) ABOVE THE FINISH FLOOR OR GROUND, AND 8 INCHES (203 MM) DEEP MINIMUM AT 27 INCHES (686 MM) ABOVE THE FINISH FLOOR OR GROUND.

OR GROUND, SHALL BE CONSIDERED KNEE CLEARANCE

11B-213.3.4, THE KNEE CLEARANCE SHALL BE 27 INCHES (686 MM) HIGH MINIMUM ABOVE THE FINISH FLOOR OR GROUND AT A DEPTH OF 8 INCHES (203 MM) MINIMUM INCREASING TO 29 INCHES (737 MM) HIGH MINIMUM ABOVE THE FINISH FLOOR OR GROUND AT THE FRONT EDGE OF A COUNTER WITH A BUILT-IN LAVATORY OR AT THE FRONT EDGE OF A

2. AT DINING AND WORK SURFACES REQUIRED TO BE ACCESSIBLE BY SECTION 11B-226.1. KNEE CLEARANCE SHALL EXTEND 19 INCHES (483 MM) DEEP MINIMUM AT 27INCHES (686 MM) ABOVE THE FINISH FLOOR OR GROUND.

TOILET ROOM ACCESSORIES

11B-213.3.5 MIRRORS. WHERE MIRRORS ARE PROVIDED, AT LEAST ONE SHALL COMPLY WITH SECTION 11B-603.3.

11B-603.3 MIRRORS. MIRRORS LOCATED ABOVE LAVATORIES OR COUNTERTOPS SHALL BE INSTALLED WITH THE BOTTOM EDGE OF THE REFLECTING SURFACE 40 INCHES (1016) , MM) MAXIMUM ABOVE THE FINISH FLOOR OR GROUND. MIRRORS NOT LOCATED ABOVE REFLECTING SURFACE 35 INCHES (889 MM) MAXIMUM ABOVE THE FINISH FLOOR OR

11B-603.5 ACCESSORIES. WHERE TOWEL OR SANITARY NAPKIN DISPENSERS, WASTE RECEPTACLES, OR OTHER ACCESSORIES ARE PROVIDED IN TOILET FACILITIES, AT LEAST ONE OF EACH TYPE SHALL BE LOCATED ON AN ACCESSIBLE ROUTE. ALL OPERABLE PARTS, INCLUDING COIN SLOTS, SHALL BE 40 INCHES (1016 MM) MAXIMUM ABOVE THE

11B-604.7 DISPENSERS. TOILET PAPER DISPENSERS SHALL COMPLY WITH SECTION 11B-BARS SHALL BE INSTALLED IN A HORIZONTAL POSITION 18 INCHES (457 MM) MINIMUM AND FRONT OF THE WATER CLOSET MEASURED TO THE CENTERLINE OF THE DISPENSER. THE 309.4 AND SHALL BE 7 INCHES (178 MM) MINIMUM AND 9 INCHES (229 MM) MAXIMUM IN OUTLET OF THE DISPENSER SHALL BE BELOW THE GRAB BAR, 19 INCHES (483 MM) MINIMUM ABOVE THE FINISH FLOOR AND SHALL NOT BE LOCATED BEHIND GRAB BARS. DISPENSERS SHALL NOT BE OF A TYPE THAT CONTROLS DELIVERY OR THAT DOES NOT ALLOW CONTINUOUS PAPER FLOW.

ACCESSIBILITY NOTES (CONT.)

ESTABLISHED FOR THE ADJACENT STREET OR HIGHWAY.

GENERAL. WALKING SURFACES THAT ARE A PART OF AN ACCESSIBLE ROUTE SHALL COMPLY WITH SECTION 11B-403.

11B-403.2 FLOOR OR GROUND SURFACE. FLOOR OR GROUND SURFACES SHALL COMPLY WITH SECTION 11B-302.

11B-403.3 SLOPE. THE RUNNING SLOPE OF WALKING SURFACES SHALL NOT BE STEEPER THAN

1:20. THE CROSS SLOPE OF WALKING SURFACES SHALL NOT BE STEEPER THAN 1:48. EXCEPTION: THE RUNNING SLOPE OF SIDEWALKS SHALL NOT EXCEED THE GENERAL GRADE

11B-403.4 CHANGES IN LEVEL. CHANGES IN LEVEL SHALL COMPLY WITH SECTION 11B-303.

11B-403.5 CLEARANCES. WALKING SURFACES SHALL PROVIDE CLEARANCES COMPLYING WITH SECTION 11B-403.5.

EXCEPTION: WITHIN EMPLOYEE WORK AREAS, CLEARANCES ON COMMON USE CIRCULATION PATHS SHALL BE PERMITTED TO BE DECREASED BY WORK AREA EQUIPMENT PROVIDED THAT THE DECREASE IS ESSENTIAL TO THE FUNCTION OF THE WORK BEING PERFORMED.

11B-403.5.1 CLEAR WIDTH. EXCEPT AS PROVIDED IN SECTIONS 11B-403.5.2 AND 11B-403.5.3, THE CLEAR WIDTH OF WALKING SURFACES SHALL BE 36 INCHES (914 MM) MINIMUM.

1. THE CLEAR WIDTH SHALL BE PERMITTED TO BE REDUCED TO 32 INCHES (813 MM) MINIMUM FOR A LENGTH OF OTHER EXISTING CONDITIONS, THE ENFORCING AGENCY DETERMINES THAT COMPLIANCE WITH THE 48-INCH (1219 MM) CLEAR SIDEWALK WIDTH WOULD CREATE AN UNREASONABLE HARDSHIP, THE CLEAR WIDTH MAY BE REDUCED TO 36 INCHES (914 MM). 2. THE CLEAR WIDTH FOR WALKING SURFACES IN CORRIDORS SERVING AN OCCUPANT LOAD OF 10 OR MORE SHALL BE 44 INCHES (1118 MM) MINIMUM

3. THE CLEAR WIDTH FOR SIDEWALKS AND WALKS SHALL BE 48 INCHES (1219 MM) MINIMUM. WHEN, BECAUSE OF RIGHT-OF-WAY RESTRICTIONS, NATURAL BARRIERS O ROTHER EXISTING CONDITIONS. THE ENFORCING AGENCY DETERMINES THAT COMPLIANCE WITH THE 48-INCH (1219 MM) CLEAR SIDEWALK WIDTH WOULD CREATE AN UNREASONABLE HARDSHIP, THE CLEAR WIDTH MAY BE REDUCED TO 36 INCHES (914 MM).

4. THE CLEAR WIDTH FOR AISLES SHALL BE 36 INCHES (914 MM) MINIMUM IF SERVING ELEMENTS ON ONLY ONE SIDE, AND 44 INCHES (1118 MM) MINIMUM IF SERVING ELEMENTS ON BOTH SIDES.

11B-403.5.2 CLEAR WIDTH AT TURN. WHERE THE ACCESSIBLE ROUTE MAKES A 180 DEGREE TURN AROUND AN ELEMENT WHICH IS LESS THAN 48 INCHES (1219 MM) WIDE, CLEAR WIDTH SHALL BE 42 INCHES (1067 MM) MINIMUM APPROACHING THE TURN, 48 INCHES (1219 MM)

MINIMUM AT THE TURN AND 42 INCHES (1067 MM) MINIMUM LEAVING THE TURN. EXCEPTION: WHERE THE CLEAR WIDTH AT THE TURN IS 60 INCHES (1524 MM) MINIMUM

COMPLIANCE WITH SECTION 11B-403.5.2 SHALL NOT BE REQUIRED.

11B-403.5.3 PASSING SPACES. AN ACCESSIBLE ROUTE WITH A CLEAR WIDTH LESS THAN 60 INCHES (1524 MM) SHALL PROVIDE PASSING SPACES AT INTERVALS OF 200 FEET (60.960 MM) MAXIMUM. PASSING SPACES SHALL BE EITHER: A SPACE 60 INCHES (1524 MM) MINIMUM BY 60 INCHES (1524 MM) MINIMUM; OR, AN INTERSECTION OF TWO WALKING SURFACES PROVIDING A T SHAPED SPACE COMPLYING WITH SECTION 11B-304.3.2 WHERE THE BASE AND ARMS OF THE T-SHAPED SPACE EXTEND 48 INCHES (1219 MM) MINIMUM BEYOND THE INTERSECTION.

11B-403.6 HANDRAILS. WHERE HANDRAILS ARE PROVIDED ALONG WALKING SURFACES WITH RUNNING SLOPES NOT STEEPER THAN 1:20 THEY SHALL COMPLY WITH SECTION 11B-505.

11B-403.7 CONTINUOUS GRADIENT. ALL WALKS WITH CONTINUOUS GRADIENTS SHALL HAVE RESTING AREAS, 60 INCHES (1524 MM) IN LENGTH, AT INTERVALS OF 400 FEET (121,920 MM) MAXIMUM. THE RESTING AREA SHALL BE AT LEAST AS WIDE AS THE WALK. THE SLOPE THE RESTING AREA IN ALL DIRECTIONS SHALL BE 1:48 MAXIMUM.

ANY PATH OF TRAVEL SHALL BE CONSIDERED A RAMP IF ITS SLOPE IS GREATER THAN 1'-0" RISE IN 20'-0" OF HORIZONTAL RUN.

THE MAXIMUM SLOPE OF A RAMP THAT SERVES ANY EXIT WAY, PROVIDES ACCESS FOR PERSONS WITH DISABILITIES OR IS IN THE PATH OF TRAVEL SHALL BE 1'-0" RISE IN 12'-0" OF HORIZONTAL RUN.

THE CROSS SLOPE OF RAMP SURFACES SHALL BE NOT GREATER THAN 1:50.

THE WIDTH OF RAMPS SHALL BE AS REQUIRED FOR STAIRWAYS AND EXITS.

PEDESTRIAN RAMPS SERVING PRIMARY ENTRANCES TO BUILDINGS HAVING AN OCCUPANT LOAD OF 300 OR MORE SHALL HAVE A MINIMUM CLEAR WIDTH OF 60".

RAMPS SERVING GROUP R OCCUPANCIES MAY BE 36" CLEAR WIDTH WHEN THE OCCUPANT LOAD IS 50 OR LESS

ALL OTHER PEDESTRIAN RAMPS SERVING PRIMARY ENTRANCES SHALL HAVE A MINIMUM

LANDINGS SHALL BE PROVIDED AT THE TOP AND BOTTOM OF EACH RAMP.

INTERMEDIATE LANDINGS SHALL BE PROVIDED AT INTERVALS NOT TO EXCEED 30" OF VERTICAL RISE AND AT EACH CHANGE OF DIRECTION.

DOORS IN ANY POSITION SHALL NOT REDUCE THE MINIMUM DIMENSION OF THE RAMP

TOP LANDINGS SHALL BE NOT LESS THAN 60" WIDE AND SHALL HAVE A LENGTH OF NOT LESS THAN 60" IN THE DIRECTION OF RAMP RUN.

LANDING TO LESS THAN 42" AND SHALL NOT REDUCE THE REQUIRED WIDTH BY MORE THAN 3"

WHEN FULLY OPENED. THE WIDTH OF THE LANDING SHALL EXTEND 24" PAST THE STRIKE EDGE OF ANY DOOR OR

GATE FOR EXTERIOR RAMPS, AND 18" PAST THE STRIKE EDGE FOR INTERIOR RAMPS. AT BOTTOM AND INTERMEDIATE LANDINGS, THE WIDTH SHALL BE AT LEAST THE SAME AS REQUIRED FOR THE RAMP.

INTERMEDIATE LANDINGS AT A CHANGE IN DIRECTION IN EXCESS OF 30 DEGREES AND BOTTOM LANDINGS SHALL HAVE A DIMENSION IN THE DIRECTION OF THE RAMP RUN OF NOT LESS THAN 72" TO ACCOMMODATE THE HANDRAIL EXTENSION.

OTHER INTERMEDIATE LANDINGS SHALL HAVE A DIMENSION IN THE DIRECTION OF RAMP RUN OF NOT LESS THAN 60".

RAMP LANDINGS ARE NOT CONSIDERED IN THE MAXIMUM HORIZONTAL DISTANCE OF EACH

11B-405.1 GENERAL. RAMPS ON ACCESSIBLE ROUTES SHALL COMPLY WITH SECTION 11B-405. EXCEPTION: IN ASSEMBLY AREAS, AISLE RAMPS ADJACENT TO SEATING AND NOT SERVING ELEMENTS REQUIRED TO BE ON AN ACCESSIBLE ROUTE SHALL NOT BE REQUIRED TO COMPLY WITH SECTION 11B-405.

11B-405.2 SLOPE. RAMP RUNS SHALL HAVE A RUNNING SLOPE NOT STEEPER THAN 1:12.

11B-405.3 CROSS SLOPE. CROSS SLOPE OF RAMP RUNS SHALL NOT BE STEEPER THAN 1:48.

11B-405.4 FLOOR OR GROUND SURFACES. FLOOR OR GROUND SURFACES OF RAMP RUNS SHALL COMPLY WITH SECTION 11B-302. CHANGES IN LEVEL OTHER THAN THE RUNNING SLOPE AND CROSS SLOPE ARE NOT PERMITTED ON RAMP RUNS.

ACCESSIBILITY NOTES (CONT.)

RAMPS (CONTINUED)

11B-405.5 CLEAR WIDTH. THE CLEAR WIDTH OF A RAMP RUN SHALL BE 48 INCHES $\,\,$ EXCEPTIONS: (1219 MM) MINIMUM.

EXCEPTIONS:

1. WITHIN EMPLOYEE WORK AREAS. THE REQUIRED CLEAR WIDTH OF RAMPS THAT ARE A PART OF COMMON USE CIRCULATION PATHS SHALL BE PERMITTED TO BE DECREASED BY WORK AREA EQUIPMENT PROVIDED THAT THE DECREASE IS ESSENTIAL TO THE FUNCTION OF THE WORK BEING PERFORMED. 2. HANDRAILS MAY PROJECT INTO THE REQUIRED CLEAR WIDTH OF THE RAMP AT EACH SIDE 3 1/2 INCHES (89 MM) MAXIMUM AT THE HANDRAIL HEIGHT. 3. THE CLEAR WIDTH OF RAMPS IN RESIDENTIAL USES SERVING AN OCCUPANT LOAD OF FIFTY OR LESS SHALL BE 36 INCHES (914 MM) MINIMUM BETWEEN

11B-405.6 RISE. THE RISE FOR ANY RAMP RUN SHALL BE 30 INCHES (762 MM) MAXIMUM.

11B-405.7 LANDINGS. RAMPS SHALL HAVE LANDINGS AT THE TOP AND THE BOTTOM OF EACH RAMP RUN. LANDINGS SHALL COMPLY WITH SECTION 11B-

IN LEVEL ARE NOT PERMITTED. EXCEPTION: SLOPES NOT STEEPER THAN 1:48 SHALL BE PERMITTED.

11B-405.7.2 WIDTH. THE LANDING CLEAR WIDTH SHALL BE AT LEAST AS WIDE AS THE WIDEST RAMP RUN LEADING TO THE LANDING.

11B-405.7.2.1: TOP LANDINGS SHALL BE 60 INCHES (1524 MM) WIDE MINIMUM.

11B-405.7.3 LENGTH. THE LANDING CLEAR LENGTH SHALL BE 60 INCHES (1524 MM) LONG MINIMUM.

11B-405.7.3.1: BOTTOM LANDINGS SHALL EXTEND 72 INCHES (1829 MM) MINIMUM IN THE DIRECTION OF RAMP RUN.

11B-405.7.4 CHANGE IN DIRECTION. RAMPS THAT CHANGE DIRECTION BETWEEN RUNS AT LANDINGS SHALL HAVE A CLEAR LANDING 60 INCHES (1525 MM) MINIMUM BY 72 INCHES (1829 MM) MINIMUM IN THE DIRECTION OF DOWNWARD TRAVEL FROM THE UPPER RAMP RUN.

11B-505.1 GENERAL. HANDRAILS PROVIDED ALONG WALKING SURFACES COMPLYING WITH SECTION 11B-403, REQUIRED AT RAMPS COMPLYING WITH SECTION 11B-405, AND REQUIRED AT STAIRS COMPLYING WITH SECTION 11B-504 AISLES. CURB RAMPS AT MARKED CROSSINGS SHALL BE WHOLLY SHALL COMPLY WITH SECTION 11B505.11B-505.2 WHERE REQUIRED. HANDRAILS CONTAINED WITHIN THE MARKINGS, EXCLUDING ANY FLARED SIDES. SHALL BE PROVIDED ON BOTH SIDES OF STAIRS AND RAMPS.

1. IN ASSEMBLY AREAS, HANDRAILS SHALL NOT BE REQUIRED ON BOTH SIDES OF AISLE RAMPS WHERE A HANDRAIL IS PROVIDED AT EITHER SIDE OR WITHIN THE AISI E WIDTH 2. CURB RAMPS DO NOT REQUIRE HANDRAILS.

3. AT DOOR LANDINGS, HANDRAILS ARE NOT REQUIRED WHEN THE RAMP RUN IS LESS THAN 6 INCHES (152 MM) IN RISE OR 72 INCHES (1829 MM) IN LENGTH.

11B-505.3 CONTINUITY. HANDRAILS SHALL BE CONTINUOUS WITHIN THE FULI

LENGTH OF EACH STAIR FLIGHT OR RAMP RUN, INSIDE HANDRAILS ON

SWITCHBACK OR DOGLEG STAIRS AND RAMPS SHALL BE CONTINUOUS BETWEEN FLIGHTS OR RUNS. EXCEPTION: IN ASSEMBLY AREAS, RAMP HANDRAILS ADJACENT TO SEATING OR COMPLY WITH SECTION 11B-406.5.3.

WITHIN THE AISLE WIDTH SHALL NOT BE REQUIRED TO BE CONTINUOUS IN

AISLES SERVING SEATING. 11B-505.4 HEIGHT. TOP OF GRIPPING SURFACES OF HANDRAILS SHALL BE 34 INCHES (864 MM) MINIMUM AND 38 INCHES (965 MM) MAXIMUM VERTICALLY ABOVE WALKING SURFACES, STAIR NOSINGS, AND RAMP SURFACES.

HANDRAILS SHALL BE AT A CONSISTENT HEIGHT ABOVE WALKING SURFACES,

11B-505.5 CLEARANCE. CLEARANCE BETWEEN HANDRAIL GRIPPING SURFACES AND ADJACENT SURFACES SHALL BE 1 1/2 INCHES (38 MM) MINIMUM. HANDRAILS MAY BE LOCATED IN A RECESS IF THE RECESS IS 3 INCHES (76 MM) MAXIMUM DEEP AND 18 INCHES (457 MM) MINIMUM CLEAR ABOVE THE TOP OF

11B-505.6 GRIPPING SURFACE. HANDRAIL GRIPPING SURFACES SHALL BE CONTINUOUS ALONG THEIR LENGTH AND SHALL NOT BE OBSTRUCTED ALONG THEIR TOPS OR SIDES. THE BOTTOMS OF HANDRAIL GRIPPING SURFACES SHALL NOT BE OBSTRUCTED FOR MORE THAN 20 PERCENT OF THEIR LENGTH. WHERE PROVIDED, HORIZONTAL PROJECTIONS SHALL OCCUR 1 1/2 INCHES (38 MM) MINIMUM BELOW THE BOTTOM OF THE HANDRAIL GRIPPING SURFACE.

THE HANDRAIL

1. WHERE HANDRAILS ARE PROVIDED ALONG WALKING SURFACES WITH SLOPES NOT STEEPER THAN 1:20, THE BOTTOMS OF HANDRAIL GRIPPING SURFACES SHALL BE PERMITTED TO BE OBSTRUCTED ALONG THEIR ENTIRE LENGTH WHERE THEY ARE INTEGRAL TO CRASH RAILS OR BUMPER GUARDS. 2. THE DISTANCE BETWEEN HORIZONTAL PROJECTIONS AND THE BOTTOM OF THE GRIPPING SURFACE SHALL BE PERMITTED TO BE REDUCED BY 1/8 INCH (3.2 CROSSINGS SHALL PROVIDE THE 48 INCHES (1219 MM) MINIMUM MM) FOR EACH ½ INCH (12.7 MM) OF ADDITIONAL HANDRAIL PERIMETER DIMENSION THAT EXCEEDS 4 INCHES (102 MM).

11B-505.7 CROSS SECTION. HANDRAIL GRIPPING SURFACES SHALL HAVE A CROSS SECTION COMPLYING WITH SECTION 11B-505.7.1 OR 11B-505.7.2.

11B-505.7.1 CIRCULAR CROSS SECTION. HANDRAIL GRIPPING SURFACES WITH A CIRCULAR CROSS SECTION SHALL HAVE AN OUTSIDE DIAMETER OF 1 1/4 INCHES (32 MM) MINIMUM AND 2 INCHES (51 MM) MAXIMUM.

11B-505.7.2 NON-CIRCULAR CROSS SECTIONS. HANDRAIL GRIPPING SURFACES WITH A NON-CIRCULAR CROSS SECTION SHALL HAVE A PERIMETER DIMENSION OF 4 INCHES (102 MM) MINIMUM AND 6 1/4 INCHES (159 MM) MAXIMUM, AND A CROSS-SECTION DIMENSION OF 2 1/4 INCHES (57 MM) MAXIMUM.

11B-505.8 SURFACES. HANDRAIL GRIPPING SURFACES AND ANY SURFACES ADJACENT TO THEM SHALL BE FREE OF SHARP OR ABRASIVE ELEMENTS AND SHALL HAVE ROUNDED EDGES.

11B-505.9 FITTINGS. HANDRAILS SHALL NOT ROTATE WITHIN THEIR FITTINGS.11B-505.10 HANDRAIL EXTENSIONS. HANDRAIL GRIPPING SURFACES SHALL EXTEND BEYOND AND IN THE SAME DIRECTION OF STAIR FLIGHTS AND RAMP RUNS IN ACCORDANCE WITH SECTION 11B-505.10.

ACCESSIBILITY NOTES (CONT.)

HANDRAILS (CONTINUED)

1. EXTENSIONS SHALL NOT BE REQUIRED FOR CONTINUOUS HANDRAILS AT THE INSIDE TURN OF SWITCHBACK OR DOGLEG STAIRS AND RAMPS.

2. IN ASSEMBLY AREAS, EXTENSIONS SHALL NOT BE REQUIRED FOR RAMP HANDRAILS IN AISLES SERVING SEATING WHERE THE HANDRAILS ARE DISCONTINUOUS TO PROVIDE ACCESS TO SEATING AND TO PERMIT CROSSOVERS WITHIN AISLES.

3. IN ALTERATIONS. WHERE THE EXTENSION OF THE HANDRAIL IN THE DIRECTION OF RAMP RUN WOULD CREATE A HAZARD, THE EXTENSION OF THE HANDRAIL MAY BE TURNED 90 DEGREES FROM THE RAMP

11B-505.10.1 TOP AND BOTTOM EXTENSION AT RAMPS. RAMP HANDRAILS SHALL EXTEND HORIZONTALLY ABOVE THE LANDING FOR 12 INCHES (305 MM) MINIMUM BEYOND THE TOP AND BOTTOM OF RAMP RUNS. EXTENSIONS SHALL RETURN TO A WALL, GUARD, OR THE LANDING SURFACE, OR SHALL BE CONTINUOUS TO THE HANDRAIL OF AN ADJACENT RAMP RUN.

11B-505.10.2 TOP EXTENSION AT STAIRS, AT THE TOP OF A STAIR FLIGHT, HANDRAILS SHALL EXTEND HORIZONTALLY ABOVE THE 11B-405.7.1 SLOPE. LANDINGS SHALL COMPLY WITH SECTION 11B-302. CHANGES LANDING FOR 12 INCHES (305 MM) MINIMUM BEGINNING DIRECTLY ABOVE THE FIRST RISER NOSING. EXTENSIONS SHALL RETURN TO A WALL, GUARD, OR THE LANDING SURFACE, OR SHALL BE CONTINUOUS TO THE HANDRAIL OF AN ADJACENT STAIR FLIGHT.

> 11B-505.10.3 BOTTOM EXTENSION AT STAIRS. AT THE BOTTOM OF A STAIR FLIGHT, HANDRAILS SHALL EXTEND AT THE SLOPE OF THE STAIR FLIGHT FOR A HORIZONTAL DISTANCE EQUAL TO ONE TREAD DEPTH BEYOND THE LAST RISER NOSING. SUCH EXTENSION SHALL CONTINUE WITH A HORIZONTAL EXTENSION OR SHALL BE CONTINUOUS TO THE HANDRAIL OF AN ADJACENT STAIR FLIGHT OR SHALL RETURN TO A WALL, GUARD, OR THE WALKING SURFACE. AT THE BOTTOM OF A STAIR FLIGHT, A HORIZONTAL EXTENSION OF A HANDRAIL SHALL BE 12 INCHES (305 MM) LONG MINIMUM AND A HEIGHT EQUAL TO THAT OF THE SLOPING PORTION OF THE HANDRAIL AS MEASURED ABOVE THE STAIR NOSINGS. EXTENSION SHALL RETURN TO A WALL, GUARD, OR THE LANDING SURFACE, OR SHALL BE CONTINUOUS TO THE HANDRAIL OF AN ADJACENT STAIR FLIGHT.

11B-406.5.1 LOCATION. CURB RAMPS AND THE FLARED SIDES OF CURB RAMPS SHALL BE LOCATED SO THAT THEY DO NOT PROJECT INTO VEHICULAR TRAFFIC LANES, PARKING SPACES, OR PARKING ACCESS EXCEPTION: DIAGONAL CURB RAMPS SHALL COMPLY WITH SECTION 11B-406.5.9.

11B-406.5.2 WIDTH. THE CLEAR WIDTH OF CURB RAMP RUNS (EXCLUDING ANY FLARED SIDES), BLENDED TRANSITIONS, AND TURNING SPACES SHALL BE 48 INCHES (1219 MM) MINIMUM.

11B-406.5.3 LANDINGS. LANDINGS SHALL BE PROVIDED AT THE TOPS OF CURB RAMPS AND BLENDED TRANSITIONS. THE LANDING CLEAR LENGTH SHALL BE 48 INCHES (1219 MM) MINIMUM. THE LANDING CLEAR WIDTH SHALL BE AT LEAST AS WIDE AS THE CURB RAMP, EXCLUDING ANY FLARED SIDES, OR THE BLENDED TRANSITION LEADING TO THE LANDING. THE SLOPE OF THE LANDING IN ALL DIRECTIONS SHALL BE

EXCEPTION: PARALLEL CURB RAMPS SHALL NOT BE REQUIRED TO

11B-406.5.4 FLOOR OR GROUND SURFACES. FLOOR OR GROUND SURFACES OF CURB RAMPS AND BLENDED TRANSITIONS SHALL COMPLY WITH SECTION 11B-405.4.

11B-406.5.5 WET CONDITIONS. CURB RAMPS AND BLENDED TRANSITIONS SHALL COMPLY WITH SECTION 11B-405.10.

11B-406.5.6 GRADE BREAKS. GRADE BREAKS AT THE TOP AND BOTTOM OF CURB RAMP RUNS SHALL BE PERPENDICULAR TO THE DIRECTION OF THE RAMP RUN. GRADE BREAKS SHALL NOT BE PERMITTED ON THE SURFACE OF RAMP RUNS AND TURNING SPACES. SURFACE SLOPES THAT MEET AT GRADE BREAKS SHALL BE FLUSH.

11B-406.5.7 CROSS SLOPE. THE CROSS SLOPE OF CURB RAMPS AND BLENDED TRANSITIONS SHALL BE 1:48 MAXIMUM.

11B-406.5.8 COUNTER SLOPE. COUNTER SLOPES OF ADJOINING GUTTERS AND ROAD SURFACES IMMEDIATELY ADJACENT TO AND WITHIN 24 INCHES (610 MM) OF THE CURB RAMP SHALL NOT BE STEEPER THAN 1:20. THE ADJACENT SURFACES AT TRANSITIONS AT CURB RAMPS TO WALKS, GUTTERS, AND STREETS SHALL BE AT THE SAME LEVEL.

11B-406.5.9 CLEAR SPACE AT DIAGONAL CURB RAMPS. THE BOTTOM OF DIAGONAL CURB RAMPS SHALL HAVE A CLEAR SPACE 48 INCHES (1219 MM) MINIMUM OUTSIDE ACTIVE TRAFFIC LANES OF THE ROADWAY. DIAGONAL CURB RAMPS PROVIDED AT MARKED CLEAR SPACE WITHIN THE MARKINGS.

11B-406.5.10 DIAGONAL CURB RAMPS. DIAGONAL OR CORNER TYPE CURB RAMPS WITH RETURNED CURBS OR OTHER WELL-DEFINED EDGES SHALL HAVE THE EDGES PARALLEL TO THE DIRECTION OF PEDESTRIAN FLOW, DIAGONAL CURB RAMPS WITH FLARED SIDES SHALL HAVE A SEGMENT OF CURB 24 INCHES (610 MM) LONG MINIMUM LOCATED ON EACH SIDE OF THE CURB RAMP AND WITHIN THE MARKED CROSSING.

11B-406.5.11 GROOVED BORDER. CURB RAMPS SHALL HAVE A GROOVED BORDER 12 INCHES (305 MM) WIDE ALONG THE TOP OF THE CURB RAMP AT THE LEVEL SURFACE OF THE TOP LANDING AND AT THE OUTSIDE EDGES OF THE FLARED SIDES. THE GROOVED BORDEF SHALL CONSIST OF A SERIES OF GROOVES 1/4 INCH (6.4 MM) WIDE BY 1/4 INCH (6.4 MM) DEEP, AT 3/4 INCH (19 MM) ON CENTER.

11B-406.5.12 DETECTABLE WARNINGS. CURB RAMPS AND BLENDED TRANSITIONS SHALL HAVE DETECTABLE WARNINGS COMPLYING WITH SECTION 11B-705.

11B-406.6 ISLANDS. RAISED ISLANDS IN CROSSINGS SHALL BE CUT THROUGH LEVEL WITH THE STREET OR HAVE CURB RAMPS AT BOTH SIDES. THE CLEAR WIDTH OF THE ACCESSIBLE ROUTE AT ISLANDS SHALL BE 60 INCHES (1524 MM) WIDE MINIMUM. WHERE CURB RAMPS ARE PROVIDED, THEY SHALL COMPLY WITH SECTION 11B-406. LANDINGS COMPLYING WITH SECTION 11B-406.5.3 AND THE ACCESSIBLE ROUTE SHALL BE PERMITTED TO OVERLAP. ISLANDS SHALL HAVE DETECTABLE WARNINGS COMPLYING WITH SECTION 11B-

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Architect of Record

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Description

55066-003

4/10/14

HUMAYDAN

A. HUMAYDEN

1/4" = 1'-0"

Palette: Issue Date: Design Manager:

Store #:

Project #

Concept:

LEED[®]AP: Production Designer

Checked by:


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G-0100

ACCESSIBILITY NOTES


ACCESSIBILITY NOTES

PERMITTED.

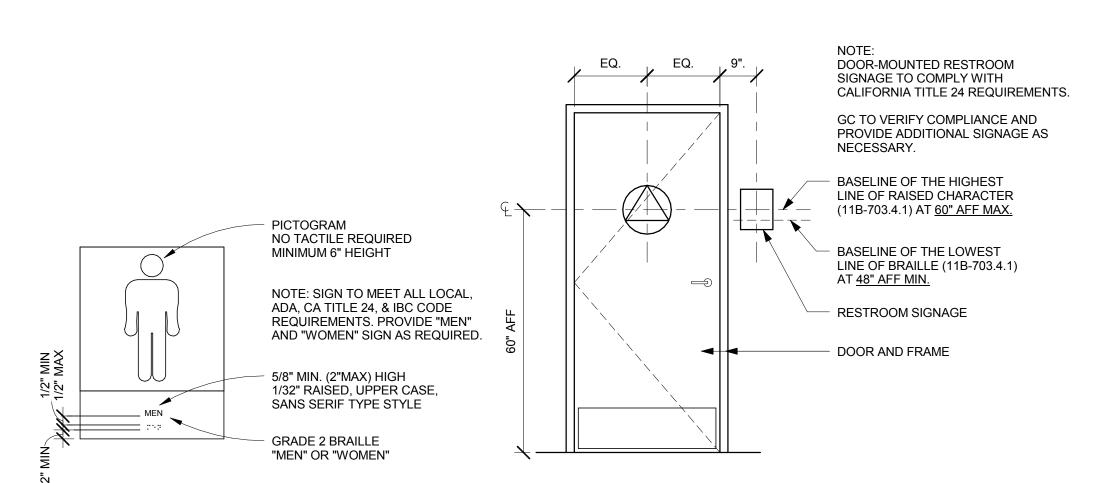

TYPICAL TOILET ROOM WALL SIGN

TYPICAL TOILET ROOM DOOR

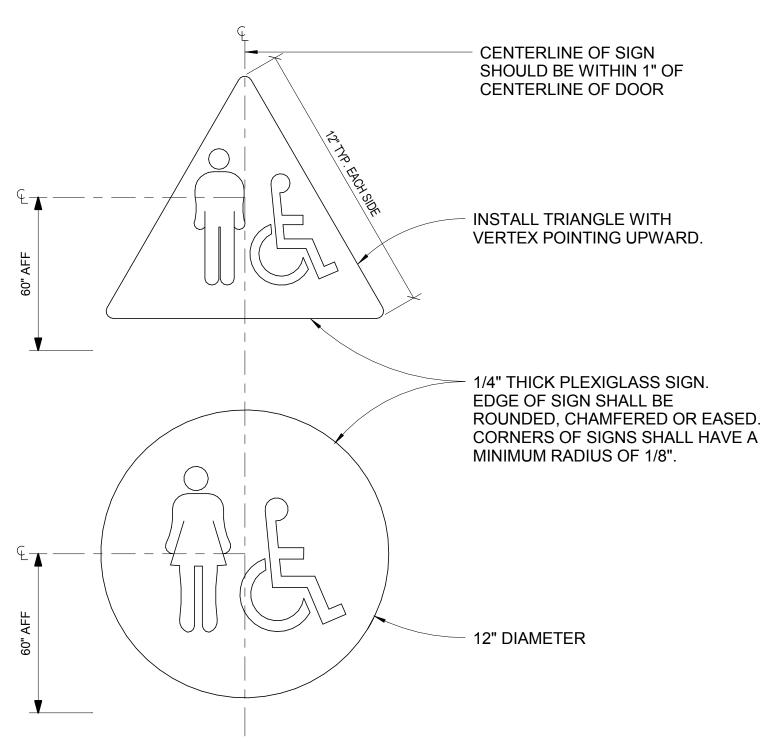

TYPICAL TOILET ROOM DOOR SIGNS

SIGNS AND IDENTIFICATION (CBC 2013 CHAPER 11B-703)

IDENTIFICATION SIGNS. WHEN SIGNS IDENTIFY PERMANENT ROOMS AND SPACES OF A BUILDING OR SITE, THEY SHALL COMPLY WITH SECTIONS 1143A.1, 1143A.5, 1143A.6 AND 1143A.7.

2. <u>DIRECTIONAL AND INFORMATIONAL SIGNS</u>: ADDITIONAL DIRECTIONAL SIGNS ALONG ACCESSIBLE PATH OF TRAVEL ARE REQUIRED.

ACCESSIBILITY SIGNS: ALL ACCESSIBLE ENTRANCES IDENTIFIED WITH A MINIMUM OF ONE STANDARD SIGN DISPLAYING THE INTERNATIONAL

RAISED CHARACTERS AND PICTORIAL SYMBOL SIGNS (CBC 2013 11B-703)

RAISED CHARACTERS SHALL COMPLY WITH SECTION 11B-703.2 AND SHALL BE DUPLICATED IN BRAILLE COMPLYING WITH SECTION 11B-703.3. RAISED CHARACTERS SHALL BE INSTALLED IN ACCORDANCE WITH SECTION 11B-703.4.

CHARACTER TYPE: RAISED CHARACTERS SHALL BE 1/32 INCH (0.8 MM) MINIMUM ABOVE THEIR BACKGROUND. CHARACTERS SHALL BE UPPERCASE, SHALL BE SANS SERIF AND ACCOMPANIED BY CONTRACTED (GRADE 2) BRAILLE. CHARACTERS SHALL NOT BE ITALIC, OBLIQUE, SCRIPT, HIGHLY DECORATIVE, OR OF OTHER UNUSUAL FORMS. (CBC 2013 11B-703.2.1)

PROPORTIONS: CHARACTERS SHALL BE SELECTED FROM FONTS WHERE THE WIDTH OF THE UPPERCASE LETTER "O" IS 60 PERCENT MINIMUM AND 110 PERCENT MAXIMUM OF THE HEIGHT OF THE UPPERCASE LETTER "I".(CBC 2013 11B-703.2.4)

CHARACTER HEIGHT: CHARACTER HEIGHT MEASURED VERTICALLY FROM THE BASELINE OF THE CHARACTER SHALL BE 5/8 INCH (15.9 MM) MINIMUM AND 2 INCHES (51 MM) MAXIMUM BASED ON THE HEIGHT OF THE UPPERCASE LETTER "I". (CBC 2013 11B-703.2.5)

STROKE THICKNESS: STROKE THICKNESS OF THE UPPERCASE LETTER "I" SHALL BE 15 PERCENT MAXIMUM OF THE HEIGHT OF THE

PICTORIAL SYMBOL SIGNS (PICTOGRAMS): PICTOGRAMS SHALL HAVE A FIELD HEIGHT OF 6 INCHES (152 MM) MINIMUM. CHARACTERS AND BRAILLE SHALL NOT BE LOCATED IN THE PICTOGRAM FIELD. PICTOGRAMS SHALL HAVE TEXT DESCRIPTORS LOCATED DIRECTLY BELOW THE PICTOGRAM FIELD. TEXT DESCRIPTORS SHALL COMPLY WITH SECTIONS 11B-703.2, 11B-703.3 AND 11B-703.4. PICTOGRAMS AND THEIR FIELD SHALL HAVE A NON-GLARE FINISH. PICTOGRAMS SHALL CONTRAST WITH THEIR FIELD WITH EITHER A LIGHT PICTOGRAM ON A DARK FIELD OR A DARK PICTOGRAM ON A LIGHT FIELD.

CHARACTER PLACEMENT: CHARACTERS AND BRAILLE SHALL BE IN A HORIZONTAL FORMAT. BRAILLE SHALL BE POSITIONED BELOW THE CORRESPONDING TEXT IN A HORIZONTAL FORMAT, FLUSH LEFT OR CENTERED. IF TEXT IS MULTI-LINED, BRAILLE SHALL BE PLACED BELOW THE ENTIRE TEXT. BRAILLE SHALL BE SEPARATED 3/8 INCH (9.5 MM) MINIMUM AND 1/2 INCH (12.7 MM) MAXIMUM FROM ANY OTHER TACTILE CHARACTERS AND 3/8 INCH (9.5 MM) MINIMUM FROM RAISED BORDERS AND DECORATIVE ELEMENTS. (CBC 2013 11B-703.2)

BRAILLE (CBC 2013 11B-703.3)

BRAILLE SHALL BE CONTRACTED (GRADE 2) AND SHALL COMPLY WITH SECTIONS 11B-703.3 AND 11B-703.4. BRAILLE DOTS SHALL HAVE A DOMED OR ROUNDED SHAPE AND SHALL COMPLY WITH TABLE 11B-703.3.1. THE INDICATION OF AN UPPERCASE LETTER OR LETTERS SHALL ONLY BE USED BEFORE THE FIRST WORD OF SENTENCES, PROPER NOUNS AND NAMES, INDIVIDUAL LETTERS OF THE ALPHABET, INITIALS, AND ACRONYMS BRAILLE SHALL BE POSITIONED BELOW THE CORRESPONDING TEXT IN A HORIZONTAL FORMAT. FLUSH LEFT OR CENTERED. IF TEXT IS MULTI-LINED. BRAILLE SHALL BE PLACED BELOW THE ENTIRE TEXT. BRAILLE SHALL BE SEPARATED 3/8 INCH (9.5 MM) MINIMUM AND 1/2 INCH (12.7 MM) MAXIMUM FROM ANY OTHER TACTILE CHARACTERS AND 3/8 INCH (9.5 MM) MINIMUM FROM RAISED BORDERS AND DECORATIVE ELEMENTS.

FINISH AND CONTRAST (CBC 2013 11B-703.5.1):

CHARACTERS, SYMBOLS AND THEIR BACKGROUNDS SHALL HAVE A NONGLARE FINISH. CHARACTERS AND SYMBOLS SHALL CONTRAST WITH THEIR BACKGROUND, EITHER LIGHT ON A DARK BACKGROUND OR DARK ON A LIGHT BACKGROUND.

MOUNTING LOCATION AND HEIGHT (CBC 2013 11B-703.4.1)

TACTILE CHARACTERS ON SIGNS SHALL BE LOCATED 48 INCHES (1219 MM) MINIMUM ABOVE THE FINISH FLOOR OR GROUND SURFACE, MEASURED FROM THE BASELINE OF THE LOWEST BRAILLE CELLS AND 60 INCHES (1524 MM) MAXIMUM ABOVE THE FINISH FLOOR OR GROUND SURFACE, MEASURED FROM THE BASELINE OF THE HIGHEST LINE OF RAISED CHARACTERS


WHERE A TACTILE SIGN IS PROVIDED AT A DOOR, THE SIGN SHALL BE LOCATED ALONGSIDE THE DOOR AT THE LATCH SIDE. WHERE A TACTILE SIGN IS PROVIDED AT DOUBLE DOORS WITH ONE ACTIVE LEAF, THE SIGN SHALL BE LOCATED ON THE INACTIVE LEAF. WHERE A TACTILE SIGN IS PROVIDED AT DOUBLE DOORS WITH TWO ACTIVE LEAFS, THE SIGN SHALL BE LOCATED TO THE RIGHT OF THE RIGHT HAND DOOR. WHERE THERE IS NO WALL SPACE AT THE LATCH SIDE OF A SINGLE DOOR OR AT THE RIGHT SIDE OF DOUBLE DOORS. SIGNS SHALL BE LOCATED ON THE NEAREST ADJACENT WALL. SIGNS CONTAINING TACTILE CHARACTERS SHALL BE LOCATED SO THAT A CLEAR FLOOR SPACE OF 18 INCHES (457 MM) MINIMUM BY 18 INCHES (457 MM) MINIMUM, CENTERED ON THE TACTILE CHARACTERS, IS PROVIDED BEYOND THE ARC OF ANY DOOR SWING BETWEEN THE CLOSED POSITION AND 45 DEGREE OPEN POSITION. WHERE PERMANENT IDENTIFICATION SIGNAGE IS PROVIDED FOR ROOMS AND SPACES THEY SHALL BE LOCATED ON THE APPROACH SIDE OF THE DOOR AS ONE ENTERS THE ROOM OR SPACE. SIGNS THAT IDENTIFY EXITS SHALL BE LOCATED ON THE APPROACH SIDE OF THE DOOR AS ONE EXITS THE ROOM OR SPACE.

15. VERTICAL CLEARANCE AT SUSPENDED SIGNS WITH MINIMUM HEADROOM OF 80" REQUIRE MINIMUM 3" CHARACTER HEIGHT MEASURED BY USING UPPERCASE "X". CHARACTERS AND NUMBERS SHALL BE SIZED ACCORDING TO VIEWING DISTANCE FROM WHICH READ. LOWER CASE CHARACTERS PERMITTED


INTERNATIONAL SYMBOL OF ACCESSIBILITY (CBC 2013 11B-703.7.2.1)

THE INTERNATIONAL SYMBOL OF ACCESSIBILITY SHALL COMPLY WITH FIGURE 11B-703.7.2.1. THE SYMBOL SHALL CONSIST OF A WHITE FIGURE ON A BLUE BACKGROUND. THE BLUE SHALL BE COLOR NO. 15090 IN FEDERAL STANDARD 595B. EXCEPTION: THE APPROPRIATE ENFORCEMENT AGENCY MAY APPROVE OTHER COLORS TO COMPLEMENT DÉCOR OR UNIQUE DESIGN. THE SYMBOL CONTRAST SHALL BE LIGHT ON DARK OR DARK ON LIGHT.

TYPICAL ACCESSIBLE SIGN REQUIREMENTS

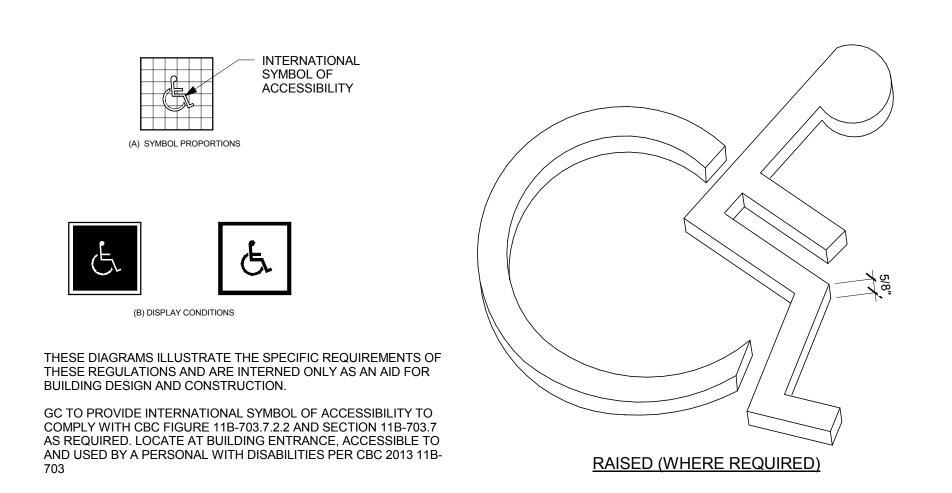




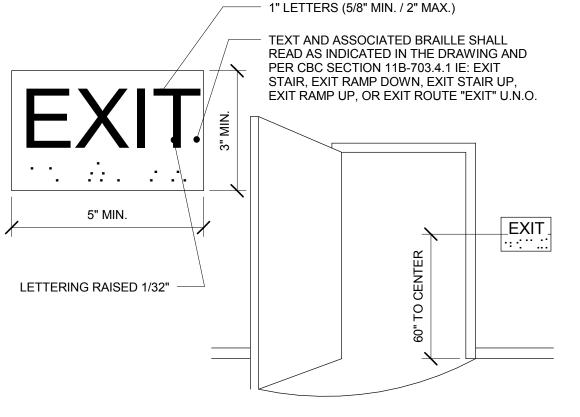

EXIT SIGN

TACTILE EXIT SIGNAGE SHALL BE COMPLIANT WITH 2013 CBC 11B-703.4

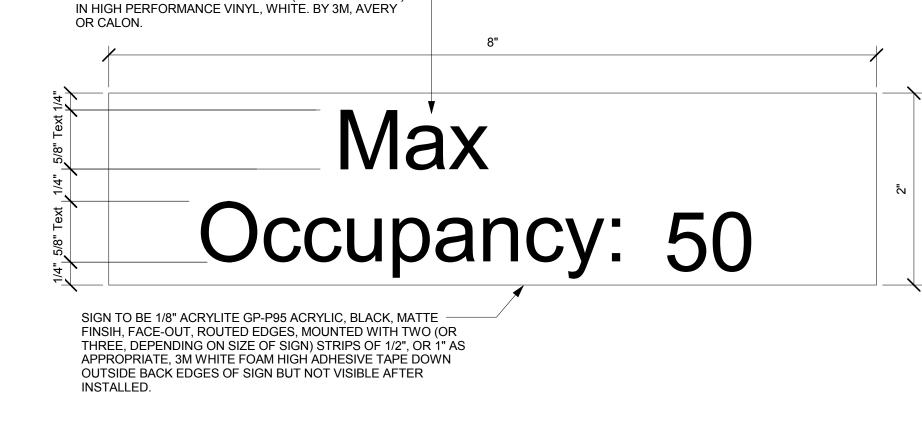

OCCUPANCY SIGN

LETTERING TO BE SWISS 721 BOLD (HELVETICA BOLD)




Starbucks Coffee

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SALASOBRIEN 305 South 11th Street an Jose, CA 95112-2218 . 408.282.1500 | f. 408.297.2995 www.salasobrien.com

Description

SARATOG

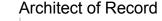Store #:

| Project # 55066-003 MCS Concept:

4/10/14

ANDREW

HUMAYDAN

As indicated

Palette: Issue Date Design Manager: LEED® AP:

Production Designer

Checked by: A. HUMAYDEN


Sheet Title:


ACCESSIBILITY DETAILS


Sheet Number:

INTERNATIONAL SYMBOL OF ACCESSIBILITY



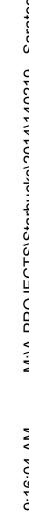

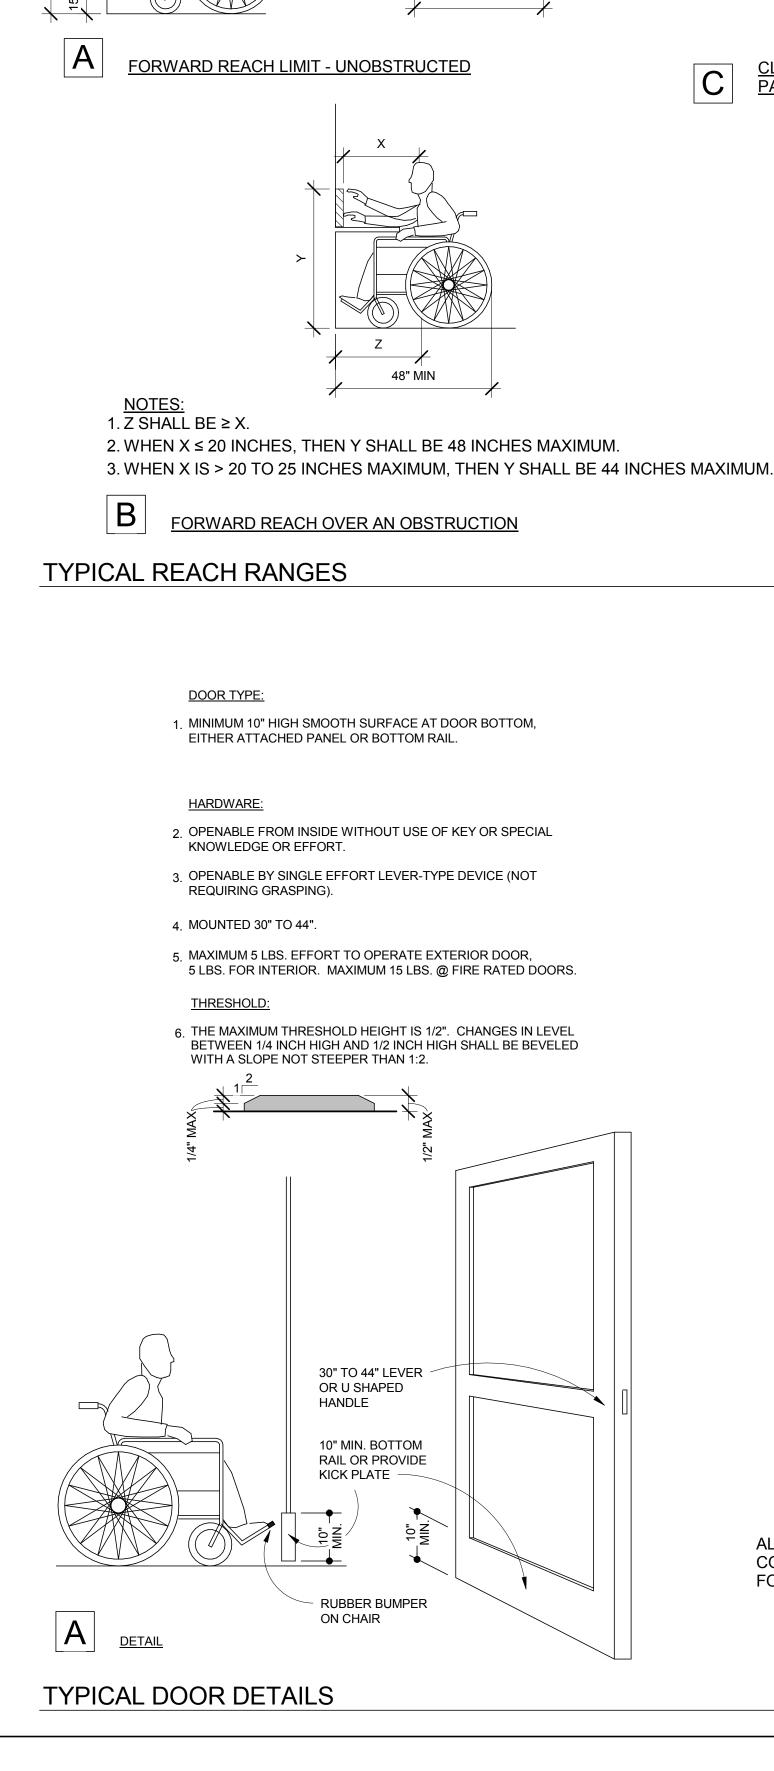

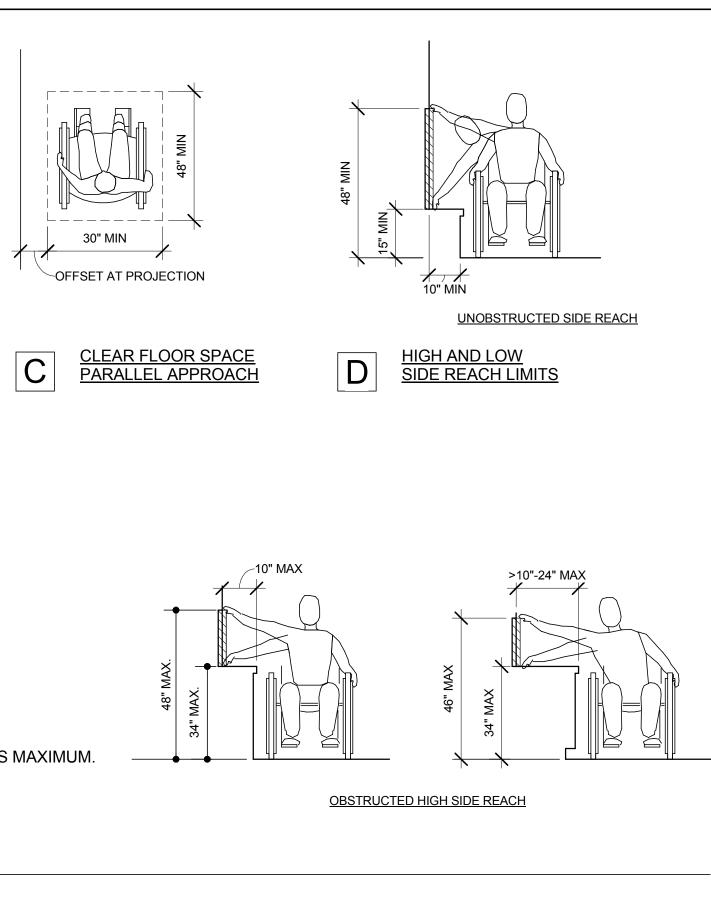

18" INTERIOR

24" EXTERIOR

LATCH

LATCH

NOTE: X=12" MIN IF DOOR

FRONT APPROACHES - SWINGING DOORS

NOTE: Y=22" MIN IF DOOR HAS BOTH A CLOSER AND

HINGE SIDE APPROACHES - SWINGING DOORS

LATCH SIDE APPROACHES - SWINGING DOORS

HAS BOTH A CLOSER AND

PULL SIDE

PULL SIDE

PULL SIDE

ALL DOOR IN ALCOVES SHALL

COMPLY WITH CLEARANCES

FOR FRONT APPROACHES


PUSH SIDE

PUSH SIDE

PUSH SIDE


NOTE: Y=48" MIN. IF DOOR

HAS CLOSER & LATCH.

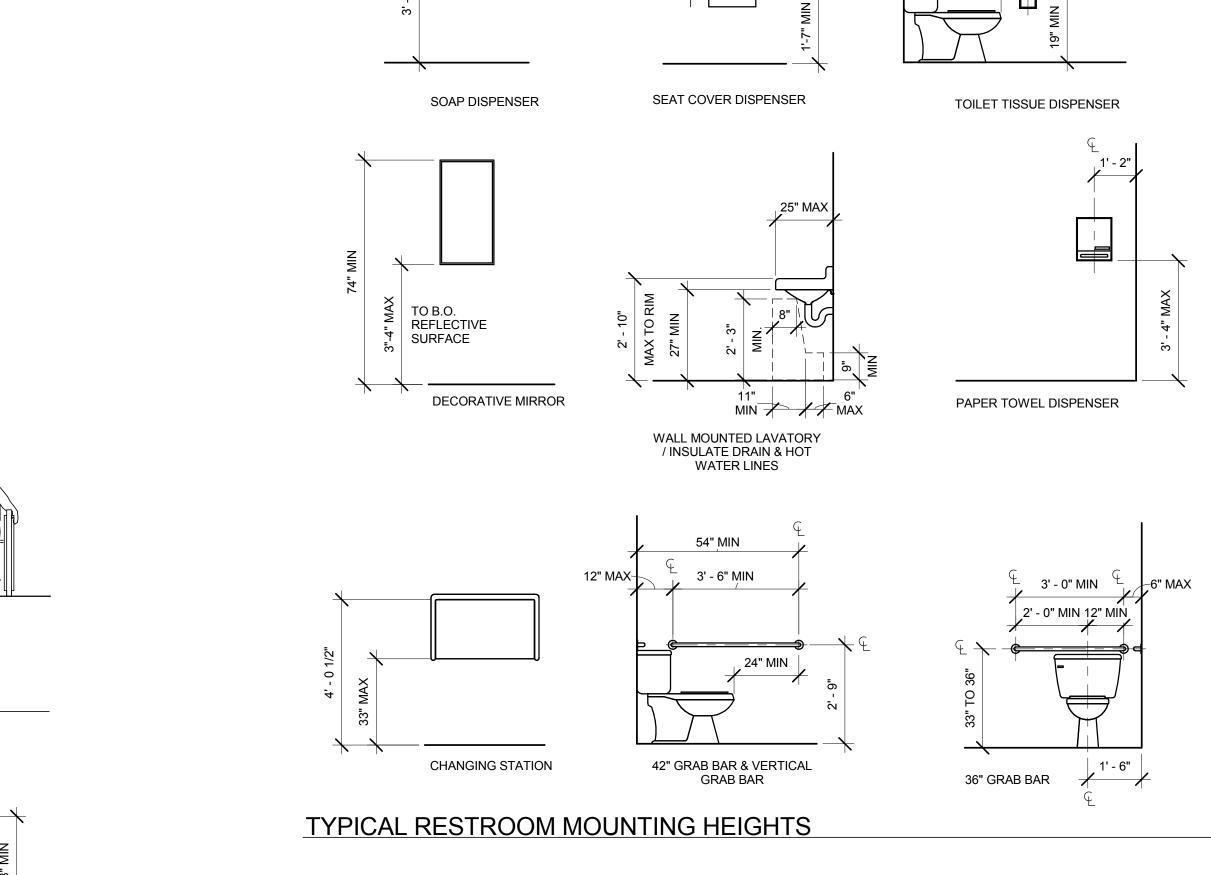

FROM TISSUE DISPENSER

7" MIN -9" MAX

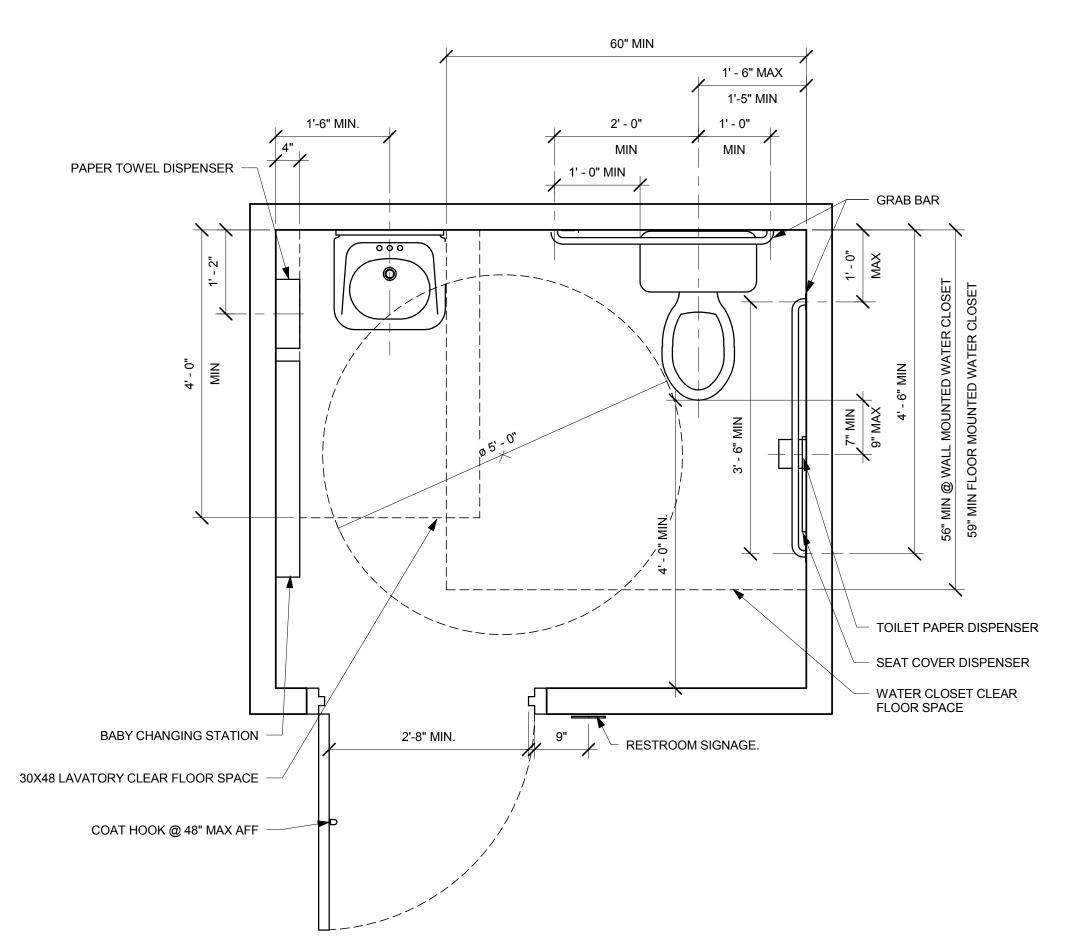





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Revision Schedule Description

403 SARAT SAN JOSE,

Store #: 20170 55066-003 Project # MCS Concept:

4/10/14

ANDREW

HUMAYDAN

A. HUMAYDEN

As indicated


Palette: Issue Date: Design Manager: LEED® AP:

Production Designer:

Checked by:

Sheet Title: **ACCESSIBILITY DETAILS**

Sheet Number: G-0102

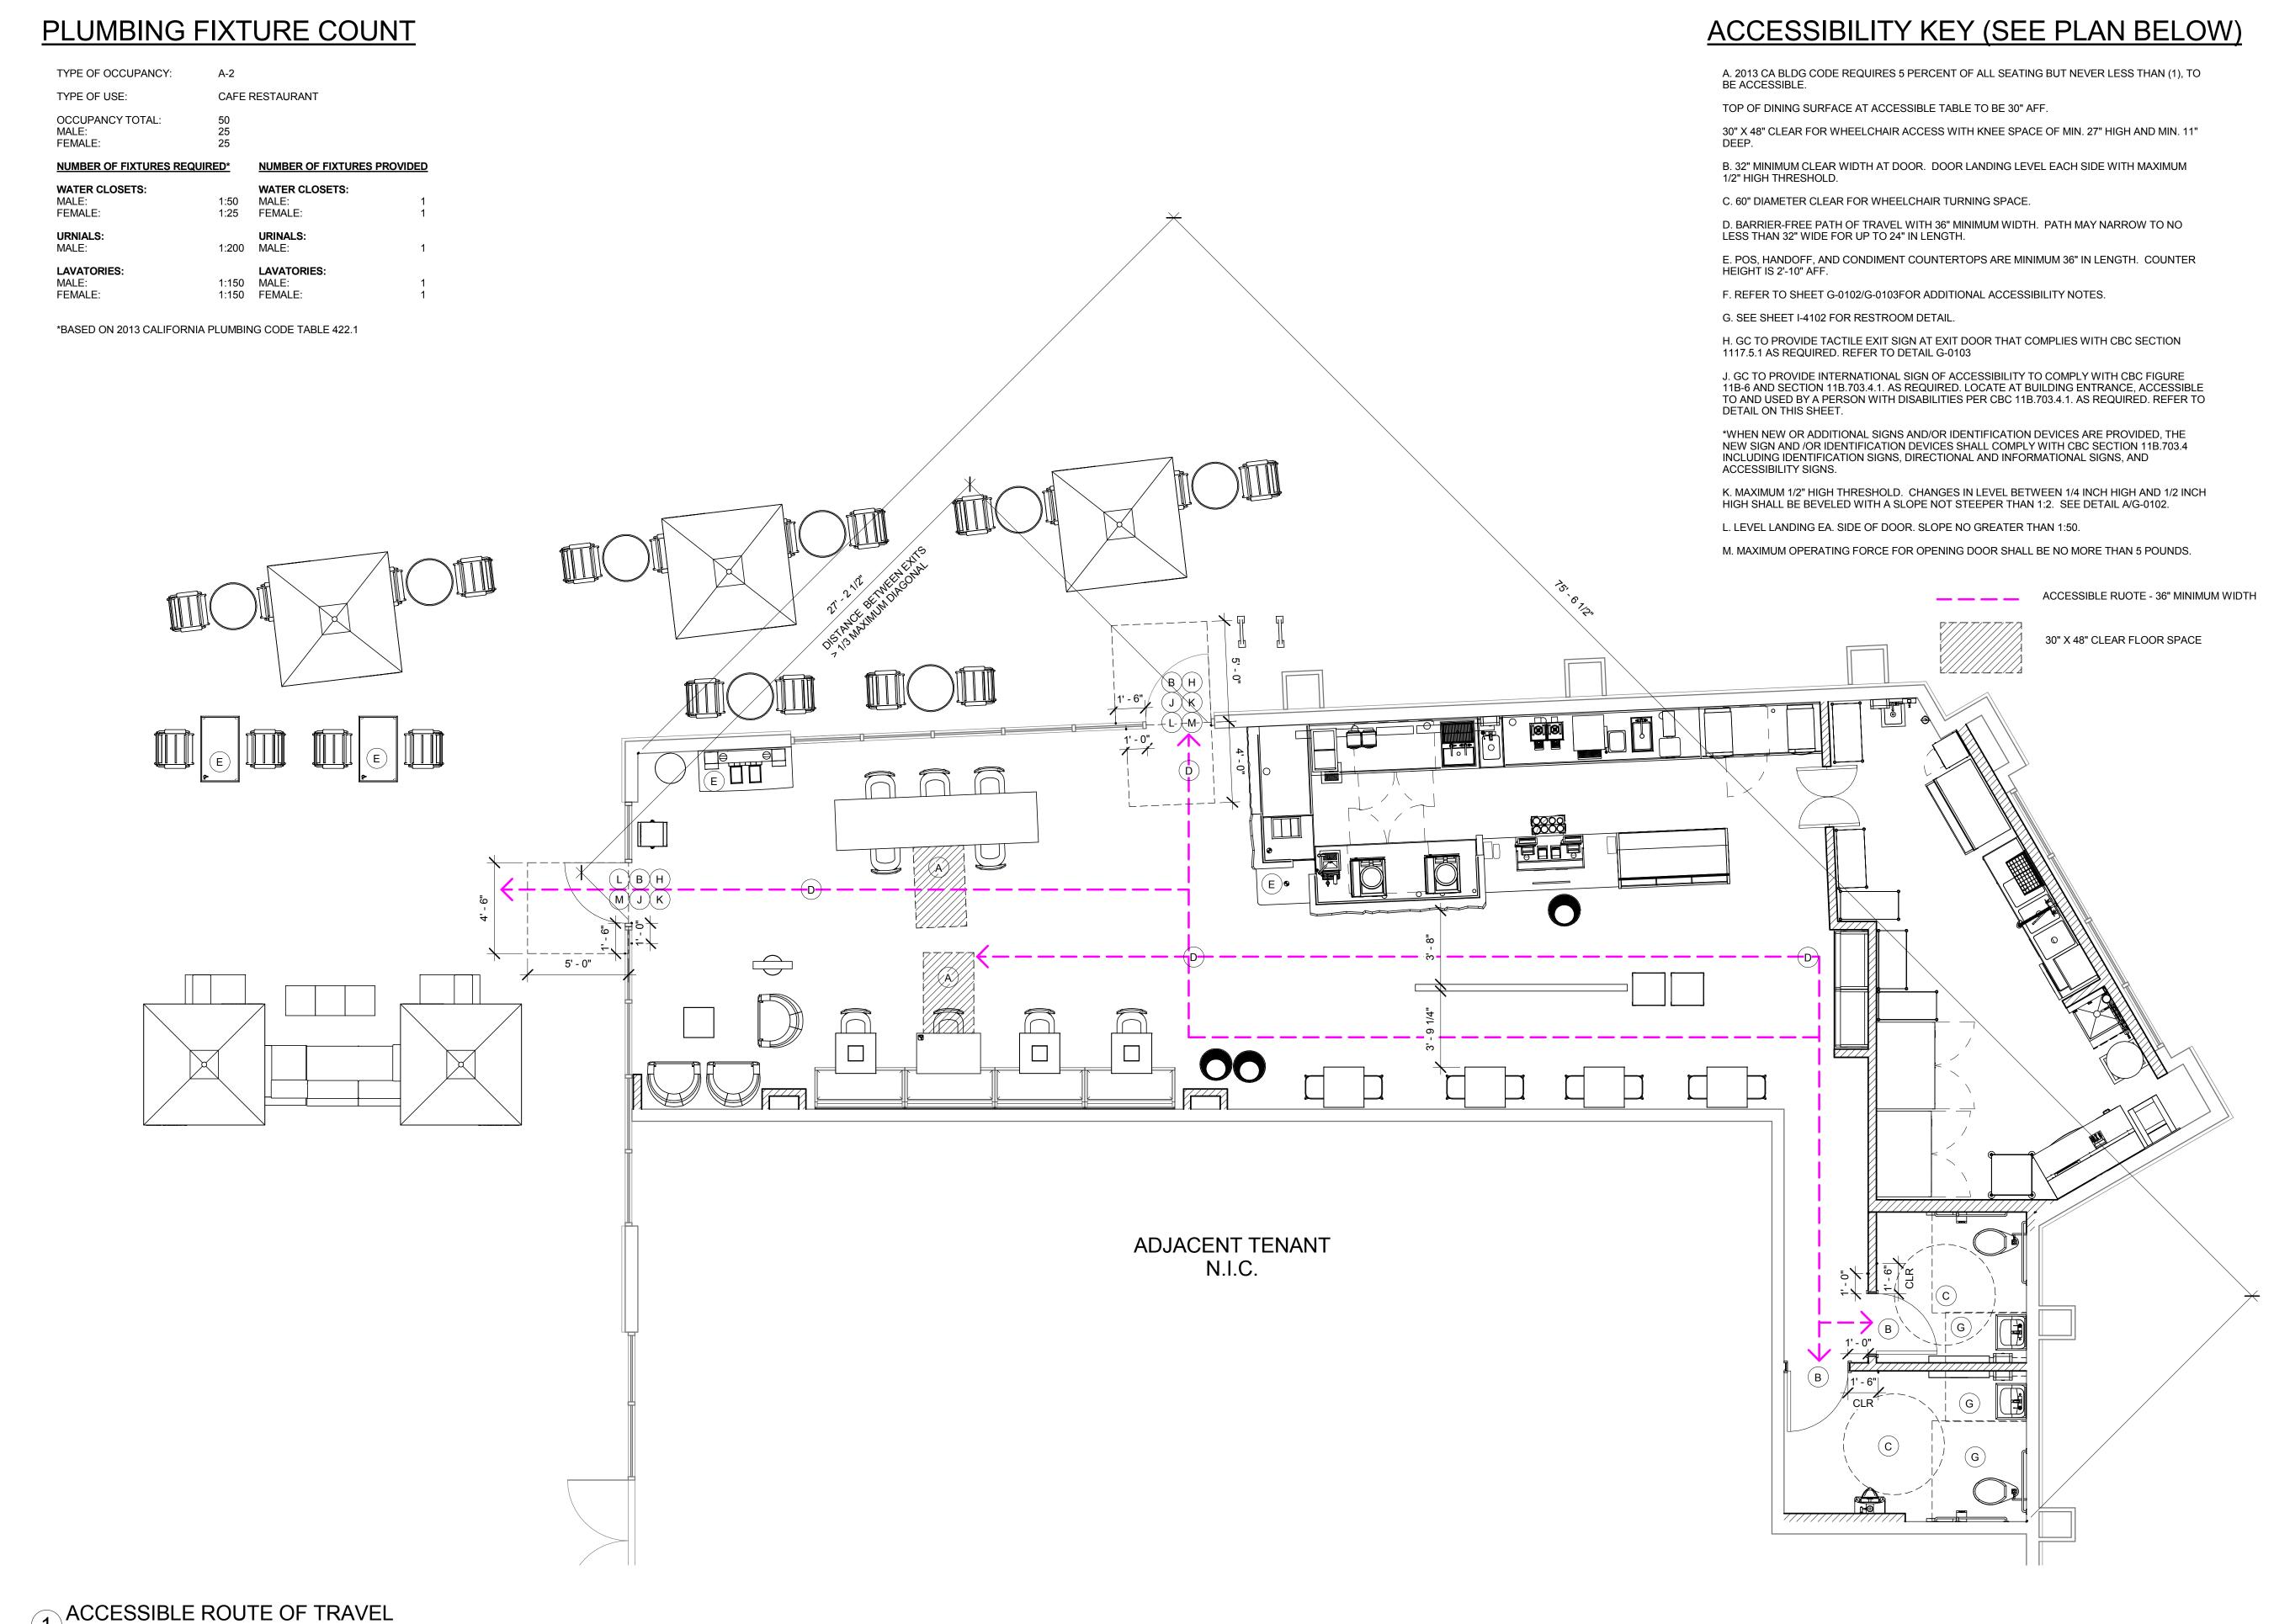



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Seattle, Washington 98134

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o. 408.282.1500 | f. 408.297.2995 www.salasobrien.com

Store #: 55066-003 Concept:

Issue Date: Design Manager: LEED® AP:

A. HUMAYDEN

ACCESSIBLE ROUTE OF TRAVEL

KIELY AVENUE

A-2001 1

EXISTING PARKING

EXISTING*

ADJACENT

TENANT

LANDSCAPING (

"EXISTING",

LANDSCAPING (

SHEET NOTES

1. ENCLOSED OUTDOOR PATIO AREA. OUTDOOR SEATING PERMIT UNDER SEPERATE PERMIT.

2. EXISTING ACCESSIBLE PARKING STALL AND ACCESSIBLE VAN PARKING STALL.

3. EXISTING PROPERTY LINE.

4. EXISTING ACCESSIBLE VAN PARKING STALL. 2% CROSS

SLOPE MAX. 5. EXTERIOR AWNINGS TO BE EQUIPPED WITH FIRE SPRINKLERS. SPRINKLERS UNDER SEPERATE PERMIT.

6. EXISTING SYMBOL OF ACCESSIBILITY PER

7. EXISTING UNLOADING ACCESS AISLE. 4" BORDER PAINTED IN BLUE WITH 4" WHITE STIPPING AT 36" O.C.


8. EXISTING ACCESSIBLE CURB RAMP.

ARCHITECTURAL SITE PLAN NOTES

A. REFER TO EXTERIOR ELEVATIONS FOR BUILDING SIGNAGE LOCATION AND DESIGN ID. REFER TO ELECTRICAL PLANS FOR ELECTRICAL REQUIREMENTS.

B. TRASH ENCLOSURE TO BE LOCKABLE USING STEEL GATES OR CHAIN TO BE PROVIDED BY LANDLORD.

__ _ _ _ ACCESSIBLE RUOTE - 36" MINIMUM WIDTH

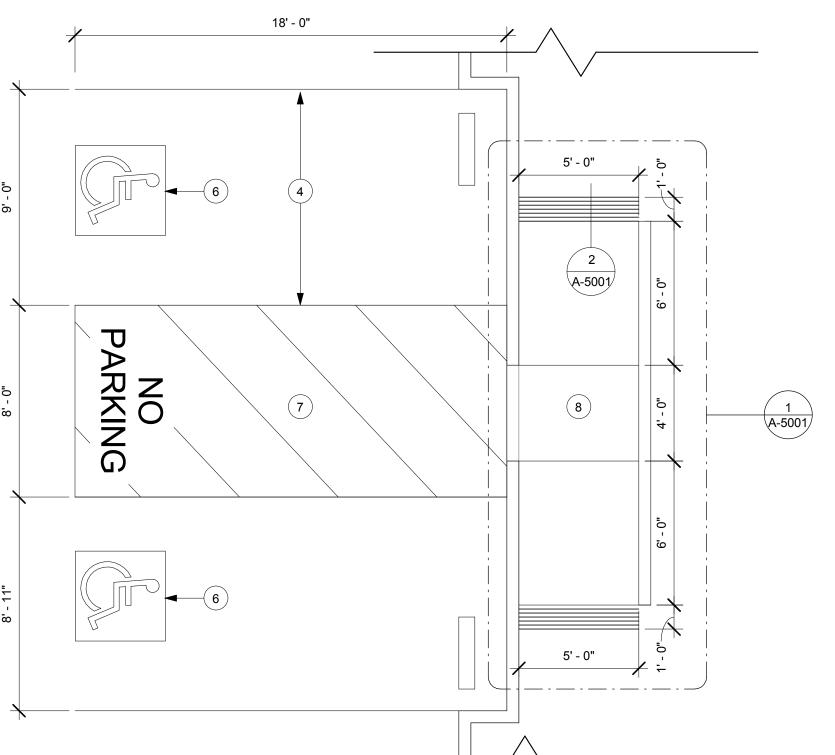

2 ENLARGED ACCESSIBLE PARKING

| Scale: 1/4" = 1'-0"

2 A-2001







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Seattle, Washington 98134 (206) 318-1575


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parties.





Rev	Date	Ву	Description

SARATOGA

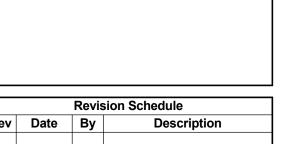Store #: 55066-003 Project #:

Concept: Palette: Issue Date:

Design Manager: LEED® AP:

ARCHITECTURAL SITE

Sheet Number:

A-1001

A. HUMAYDEN

PLAN As indicated




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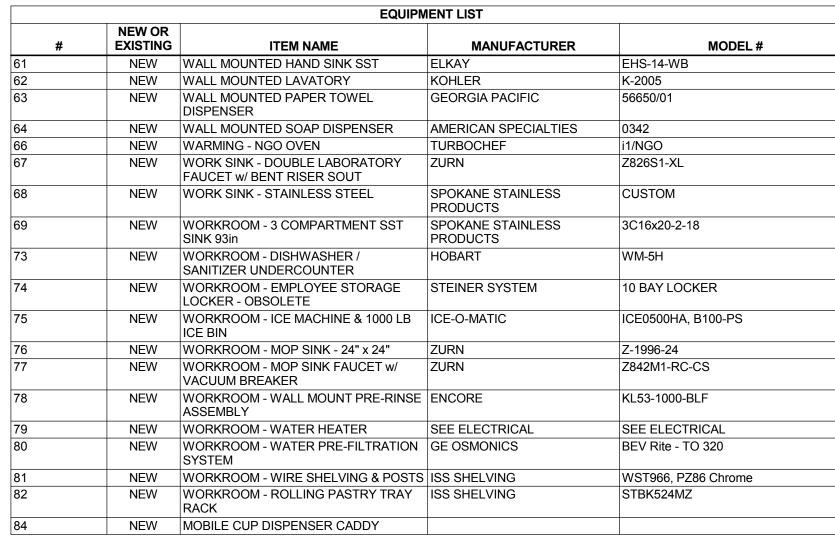
Scale: 1/4" = 1'-0"


HEALTH DEPARTMENT PLAN



TOTAL SEATS

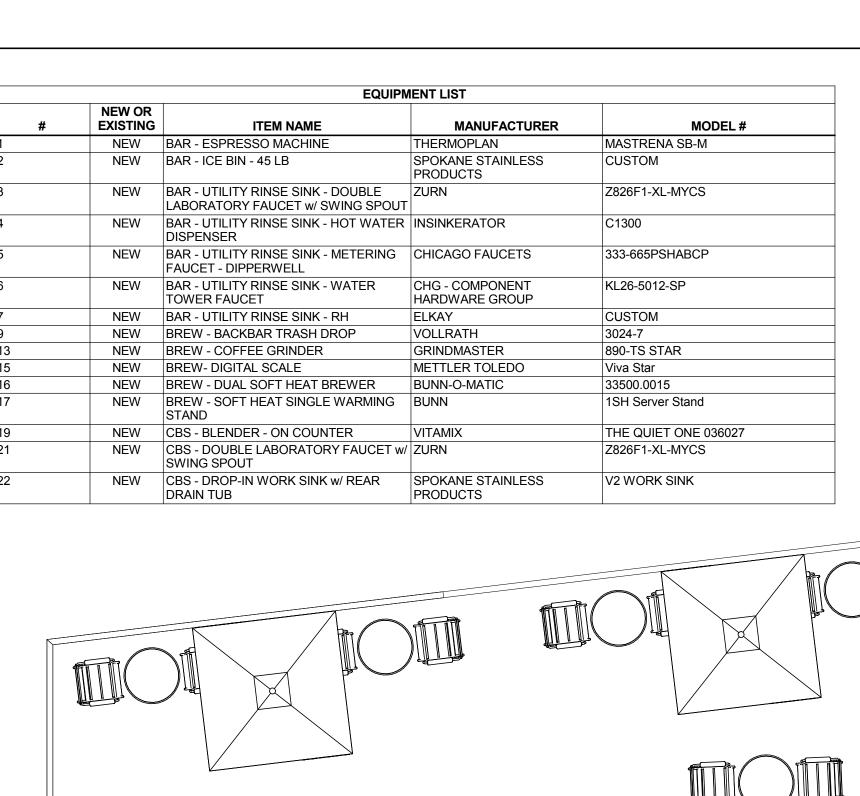EQUIPMENT LIST						
#	NEW OR EXISTING	ITEM NAME	MANUFACTURER	MODEL #		
23	NEW	CBS - ICE BIN - 90 LB	ELKAY	CUSTOM		
24	NEW	CBS - SINGLE LABORATORY FAUCET w/ SWING SPOUT	ZURN	Z-825F1-XL		
28	NEW	CONDIMENT CART & TRASH DROP	SYNSOR	CUSTOM		
30	NEW	FLOOR SINK 12x12	ZURN	FD2375-NH3		
35	NEW	FREEZER - REACH IN - 2 DOOR	TRUE	TG2F-2S		
36	NEW	HAND SINK - FAUCET SINGLE HANDLE	ZURN	Z7440-XL-FC		
37	NEW	HAND SINK - LAVATORY MOUNTED SOAP DISPENSER	AMERICAN SPECIALTIES	0332		
38	NEW	HAND SINK - STAINLESS STEEL w/ 12" SPLASH GUARDS	ELKAY	V340		
42	NEW	PASTRY CASE w/ SELF SERVE - 'A'	STRUCTURAL CONCEPTS	OASIS SB5766.3923A		
46	NEW	POS TERMINAL - CASH REGISTER	IBM	4695		
51	NEW	REFRIGERATOR - REACH IN - 2 DOOR	DELFIELD	6051XL-S		
55	NEW REFRIGERATOR - UNDERCOUNTER - 1 DOOR		DELFIELD	406 STAR 4		
58	NEW	REFRIGERATOR - UNDERCOUNTER - 2 DOOR	DELFIELD	UC4048		
59	NEW	SNEEZE GUARDS TO 60" AFF	CUSTOM	CUSTOM		



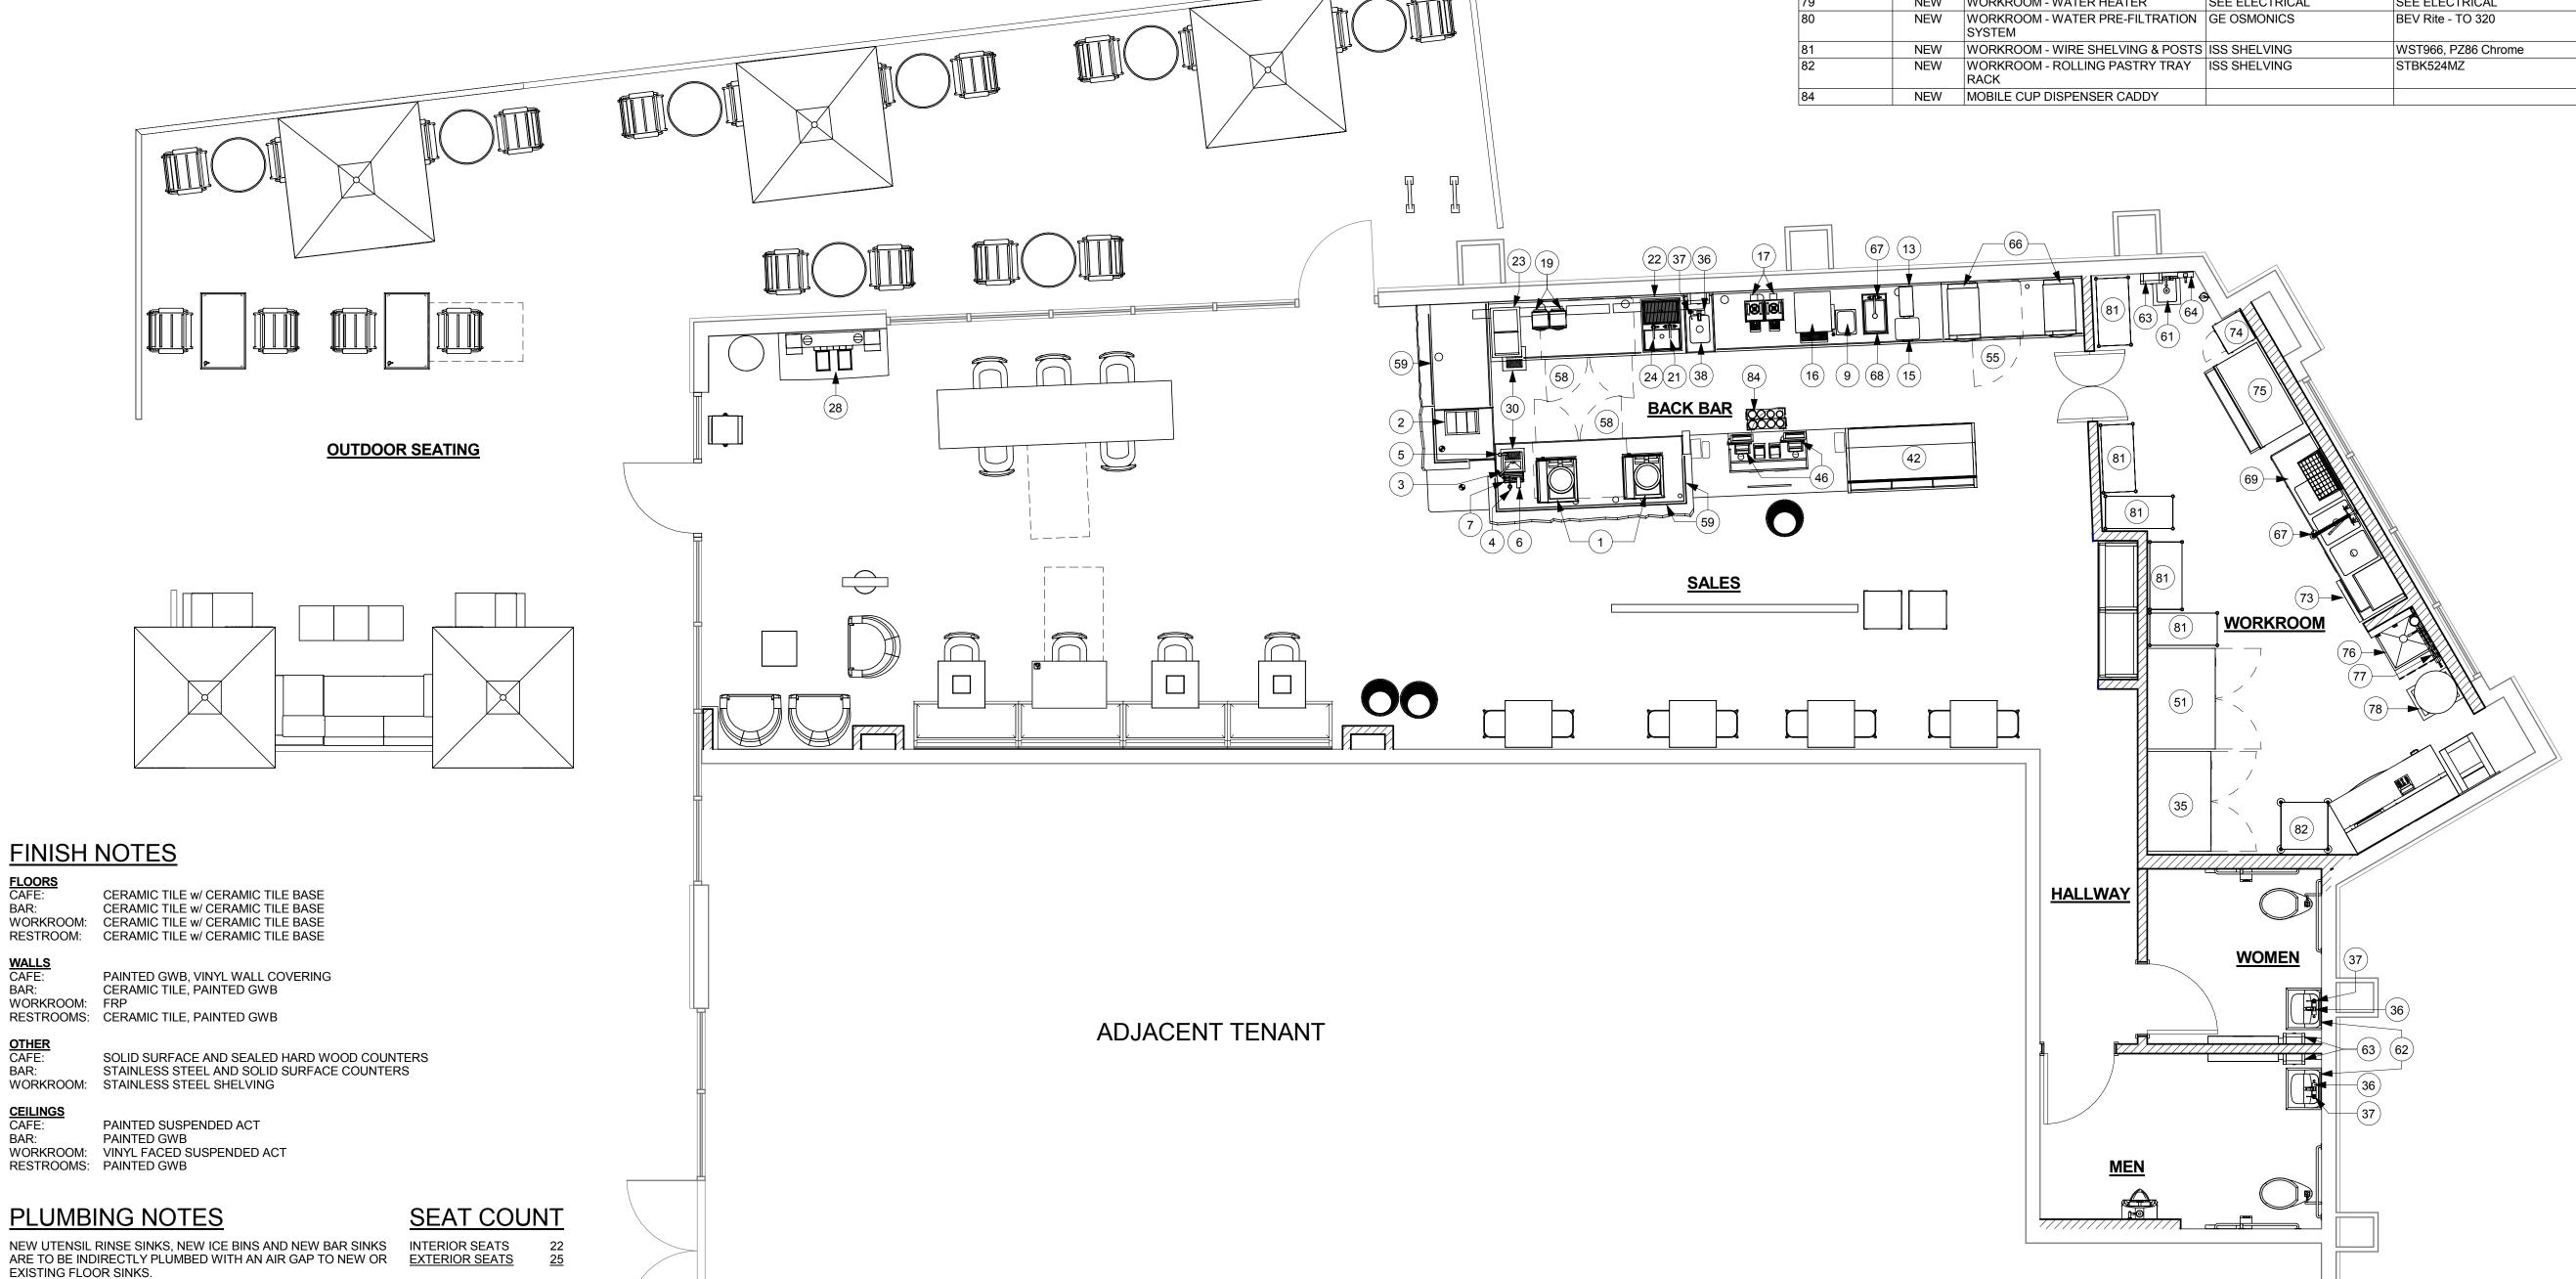



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Architect of Record SALASOBRIEN

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Revision Schedule Description

Store #: 55066-003 Project # MCS Concept:

Palette: 4/10/14 Issue Date: Design Manager: ANDREW

LEED® AP:


Production Designer: A. HUMAYDEN Checked by:


HEALTH DEPARTMENT PLAN 1/4" = 1'-0"

HUMAYDAN

Sheet Number:

A-1002

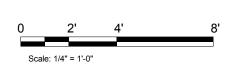

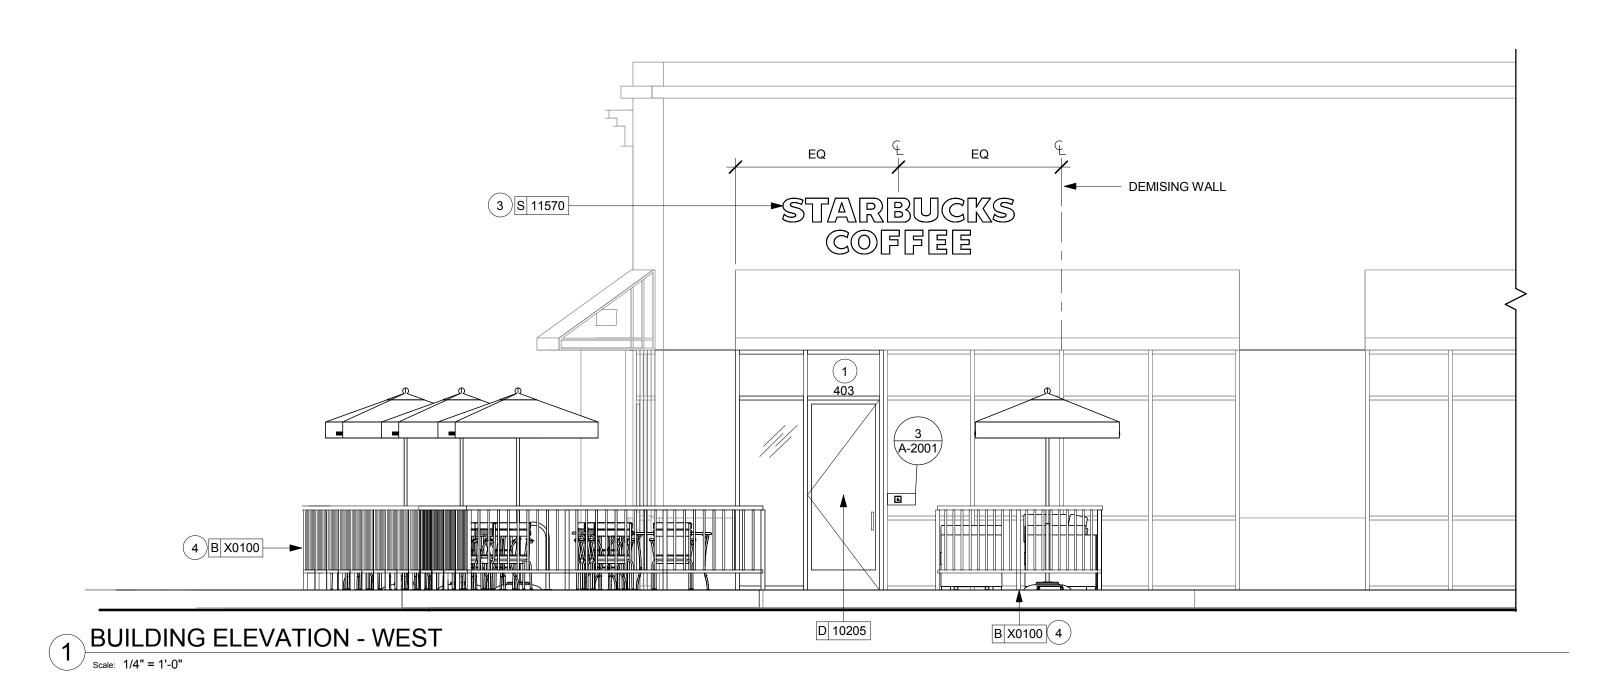

SHEET NOTES

1. PROVIDE 3" (75MM) HIGH BLACK ACRYLIC STORE ADDRESS ON GLAZING.

2. NEW EXTERIOR WALL MOUNTED ILLUMINATED EVOLVED LOGO SIGN DISC . SIGNAGE UNDER SEPERATE

3. NEW NON ILLUMINATED WALL MOUNTED WORDMARK SIGN. 16" TALL WHITE LETTERS WITH BLACK REVEAL. TYP. CENTER SIGN OVER WINDOW AND DEMISING WALL. SIGNAGE UNDER SEPERATE PERMIT.

4. NEW 42" HIGH RAILING. SURFACE MOUNTED TO EXISTING CONCRETE.

RAILING BASIS OF DESIGN: HANSEN ARCHITECTURAL SYSTEMS 42" SERIES 300 PICKET RAILING

A. ATTACHMENT: SURFACE MOUNTED B. POSTS: 2.375" SQUARE, 0.1000" WALL THICKNESS

C. PICKETS: 0.75" DIA., 0.062" WALL THICKNESS D. TOP RAIL: SERIES 500, 0.0866" WALL THICKNESS

E. FINISH: BLACK ANODIZED

EXTERIOR ELEVATION NOTES

A. GENERAL CONTRACTOR TO COORDINATE AND SCHEDULE SIGNAGE INSTALLATION WITH THE SIGNAGE CONTRACTOR PROVIDING A MINIMUM SCHEDULING NOTICE OF 4 WEEKS AND 1 WEEK PRIOR TO SCHEDULED DATE OF INSTALLATION. STARBUCKS CONSTRUCTION MANAGER TO PROVIDE GENERAL CONTRACTOR WITH SIGNAGE CONTRACTOR CONTACT INFORMATION.

B. GENERAL CONTRACTOR SHALL COORDINATE WITH ELECTRICAL CONTRACTOR TO FURNISH AND INSTALL ELECTRICAL CIRCUITS INCLUDING ALL CONDUIT, WIRE, CONNECTIONS, AND BREAKER AT PANEL BOARD NECESSARY TO SERVE SIGNAGE.


C. GENERAL CONTRACTOR TO PROVIDE FIRE TREATED WOOD STUD BLOCKING, OR EQUIVALENT TO SUPPORT SIGNAGE.

D. SIGNAGE CONTRACTOR SHALL VERIFY SIZE AND LOCATION OF ANY AND ALL ALLOWABLE MONUMENT OR POLE SIGNAGE WITH LANDLORD AND PROVIDE SHOP DRAWING(S) PRIOR TO FABRICATION TO STARBUCKS DESIGNER FOR APPROVAL.

E. SIGNAGE CONTRACTOR TO INSTALL SIGNAGE IN COMPLIANCE WITH LOCAL CODES AND OBTAIN PERMIT AND LANDLORD APPROVAL.


F. SIGNAGE CONTRACTOR TO SUPPLY SHOP DRAWINGS TO STARBUCKS CONSTRUCTION MANAGER AND TO THE GENERAL CONTRACTOR AS NEEDED. GENERAL CONTRACTOR TO NOTIFY STARBUCKS CONSTRUCTION MANAGER IMMEDIATELY IF SHOP DRAWINGS OR INSTALLATION IS IN DISCREPANCY WITH STARBUCKS ARCHITECTURAL DRAWINGS.


G. GENERAL CONTRACTOR TO CLEAN, PATCH AND REPAIR EXISTING EXTERIOR AS REQUIRED.

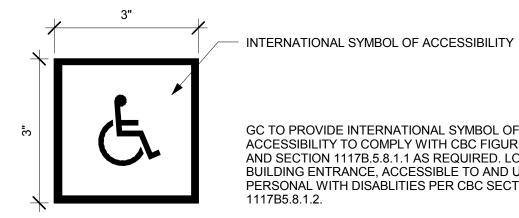

GC TO PROVIDE INTERNATIONAL SYMBOL OF ACCESSIBILITY TO COMPLY WITH CBC FIGURE 11B-6 AND SECTION 1117B.5.8.1.1 AS REQUIRED. LOCATE AT BUILDING ENTRANCE, ACCESSIBLE TO AND USED BY A PERSONAL WITH DISABLITIES PER CBC SECTION 1117B5.8.1.2.


3 ACCESSIBLE TACTILE SIGNAGE

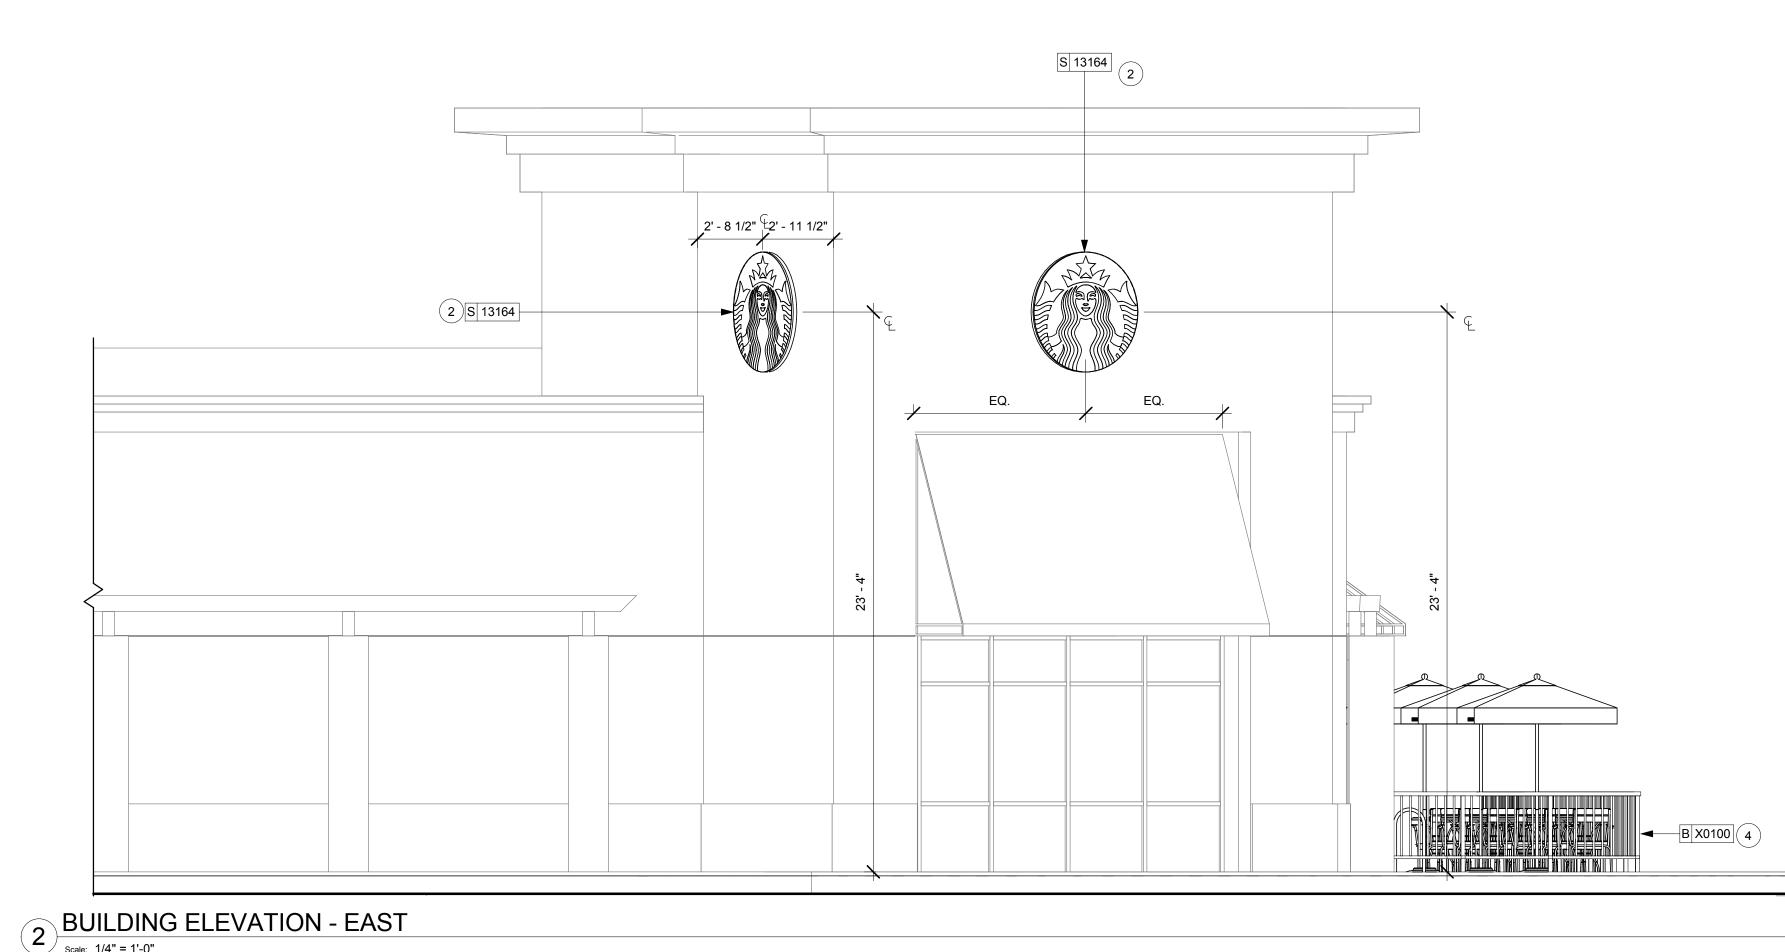

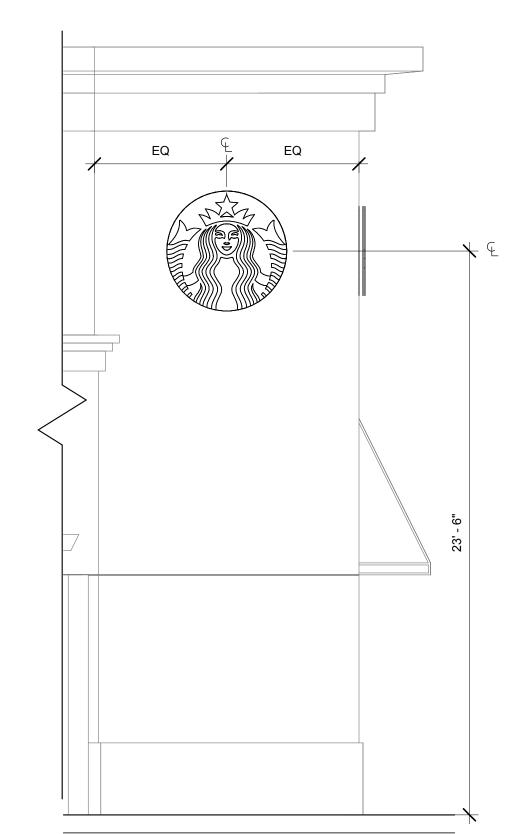

BUILDING ELEVATION - SOUTH EAST

| Scale: 1/4" = 1'-0"

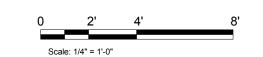



Starbucks Coffee Company

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				l
		Revis	sion Schedule	
Rev	Date	Ву	Description	

Store #: 55066-003

Project # Concept:

Issue Date: Design Manager: LEED® AP:


Production Designer

A. HUMAYDEN

EXTERIOR ELEVATIONS As indicated

Sheet Number:

A-2001

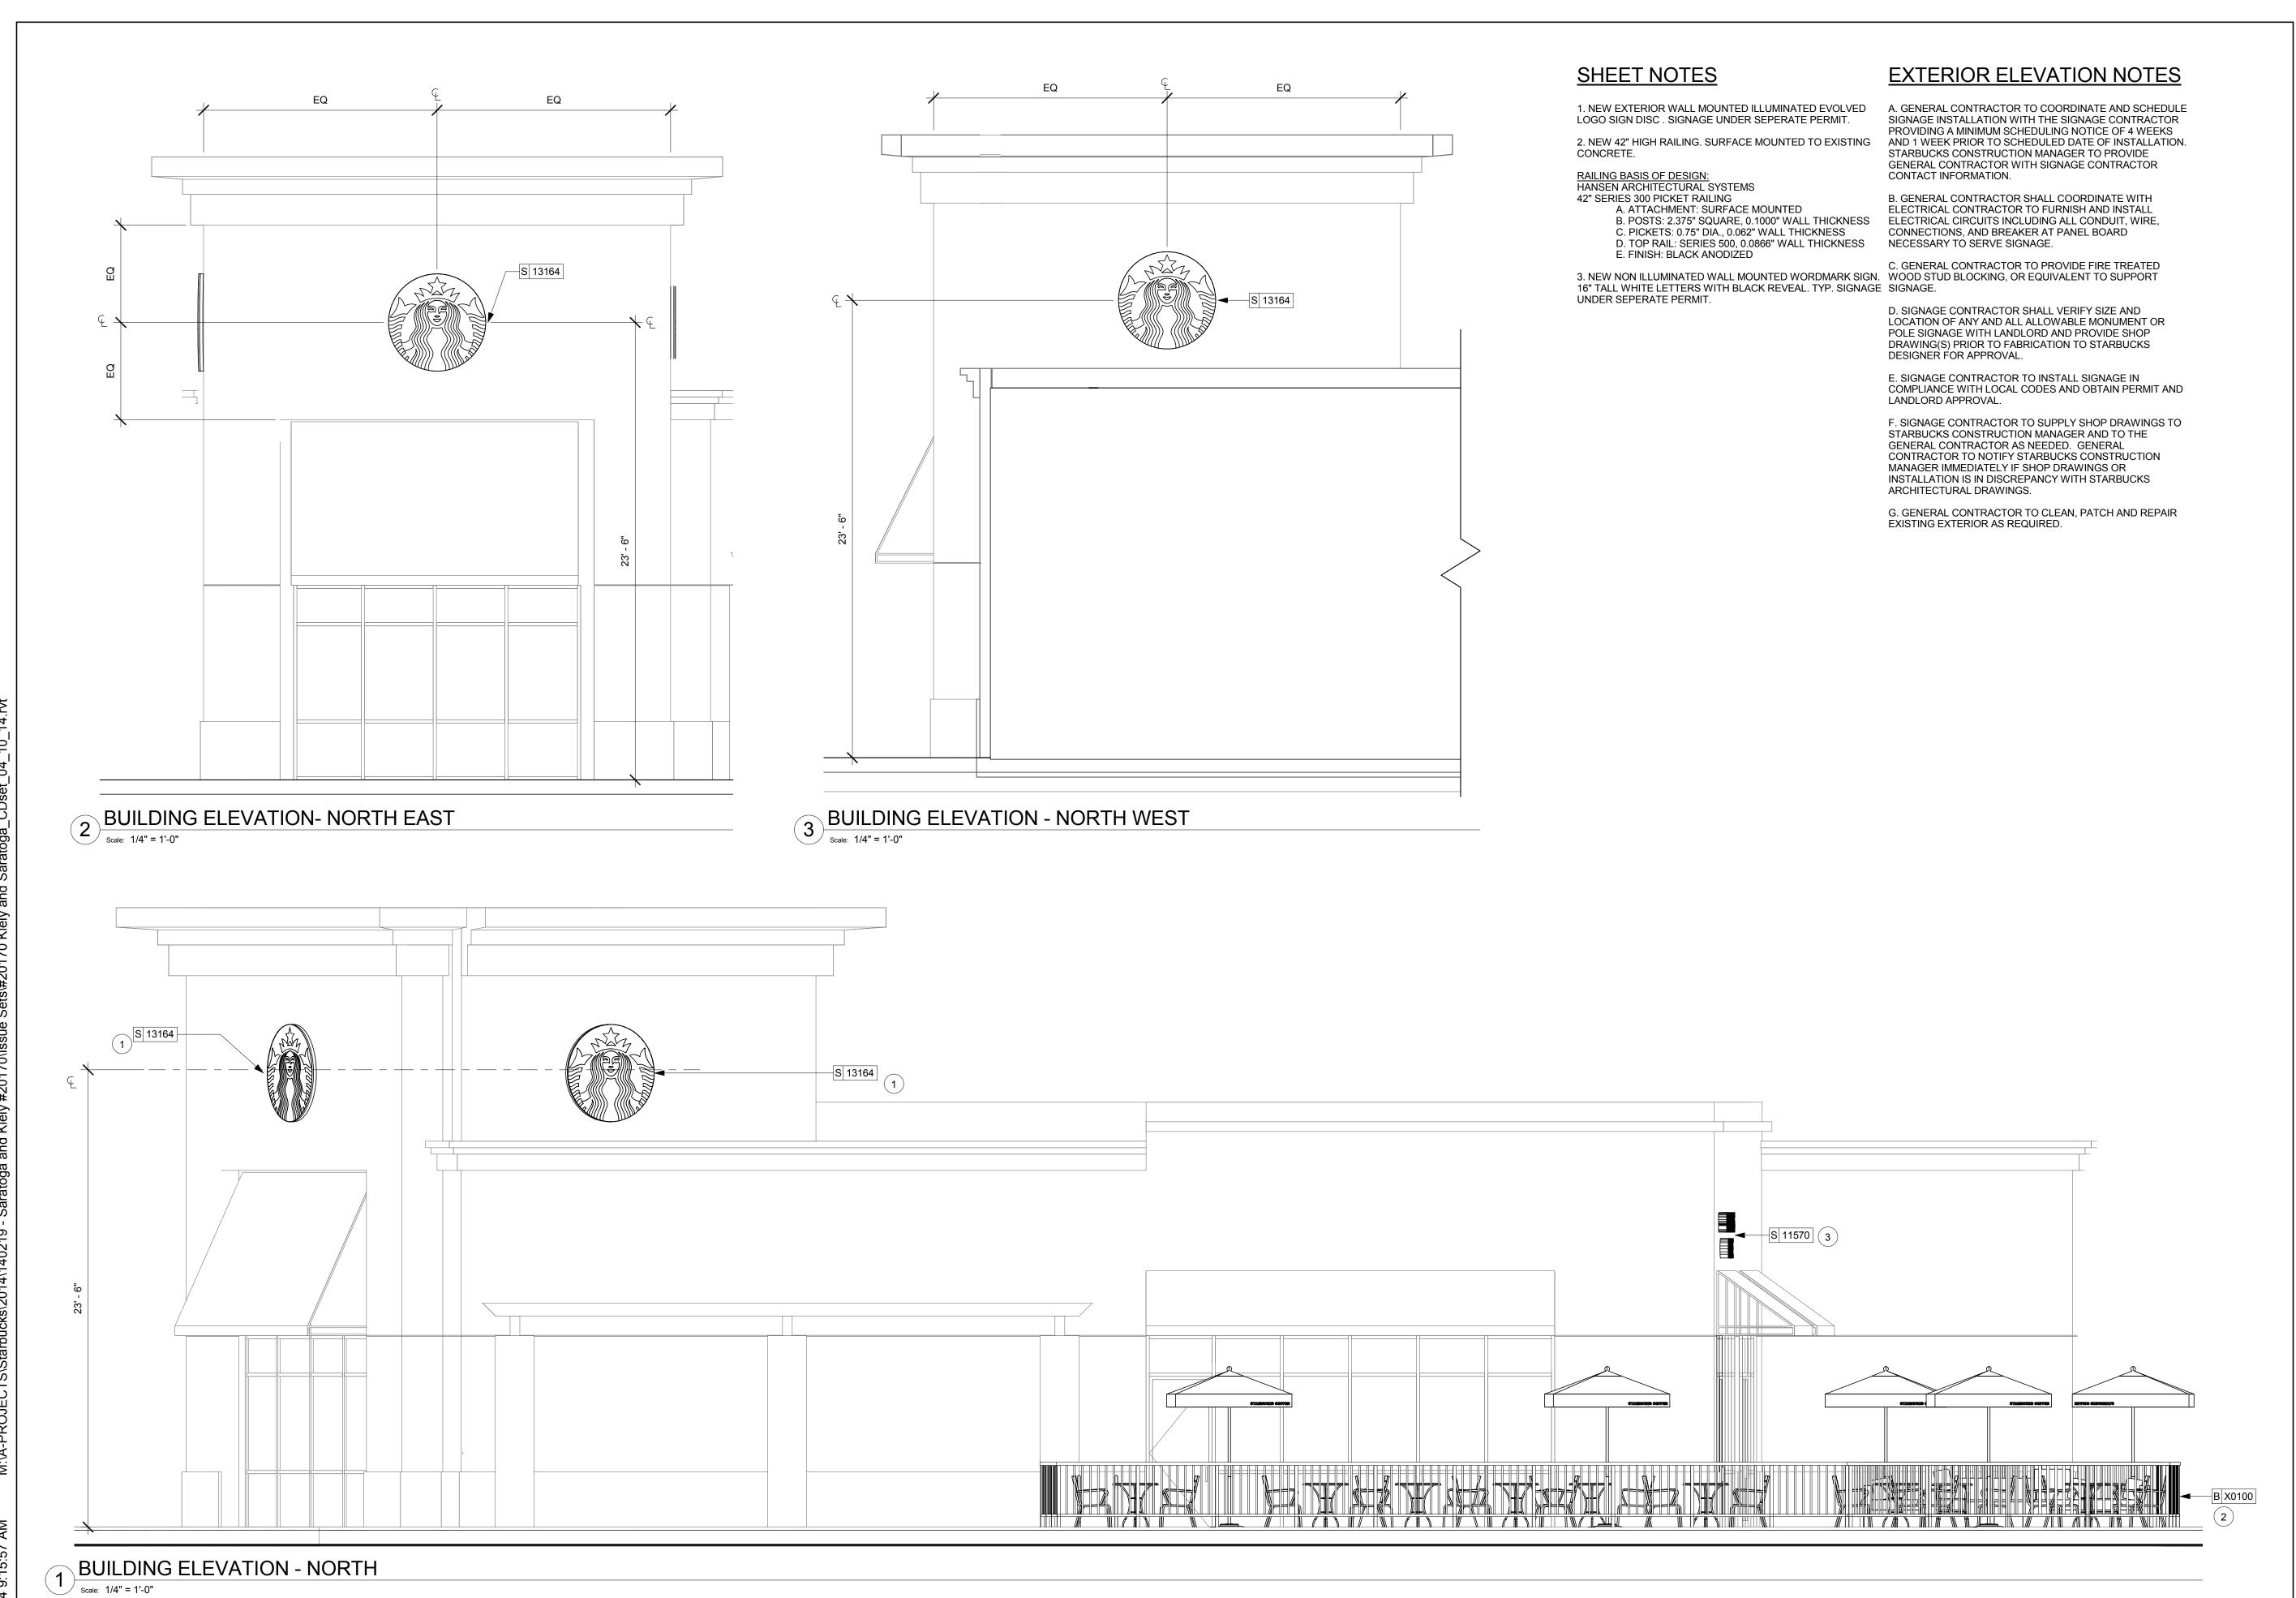



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Revision Schedule Description

SARATOGA Project Address: 403 SARATOGA AVE SAN JOSE, CA 95129

Project Name: KIELY & \$ Store #: 55066-003 Project #

Concept: Palette: Issue Date:

Design Manager: LEED® AP:

Production Designer

Sheet Title: **EXTERIOR**


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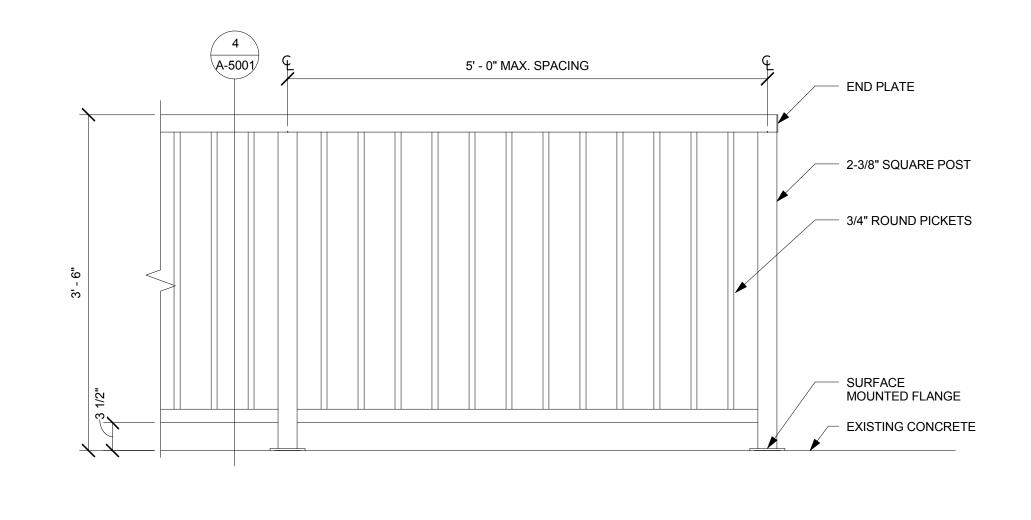
A-2002


A. HUMAYDEN

ELEVATIONS

1/4" = 1'-0"



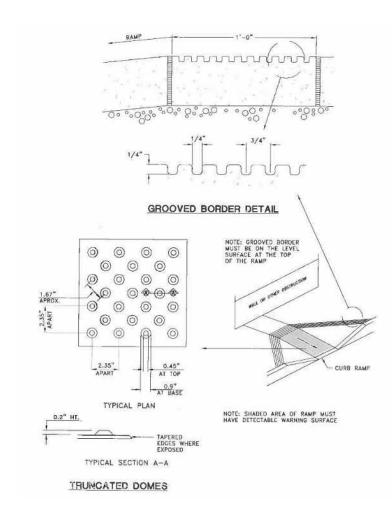

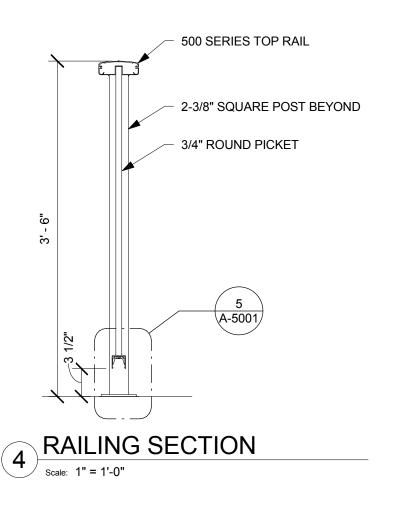

CURB RAMP Scale: 1/4" = 1'-0"

DETECTABLE WARNINGS

RAILING ELEVATION

Scale: 1" = 1'-0"

3/8" x 3-3/4" SS —— WEDGE ANCHORS, PAINTED BLACK EXIST CONCRETE SLAB EDGE 6x ANCHOR DIA. MIN.—

5 RAILING SURFACE MOUNT DETAIL

Scale: 1 1/2" = 1'-0"

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Revision Schedule Description

Store #: Project #: 55066-003

Concept:

Design Manager:

LEED® AP:

A. HUMAYDEN

ARCHITECTURAL SITE **DETAILS**

As indicated

A-5001

Sheet Number:

HEIGHT AFF

3'-0" TO 3'-4"

5'-8" TO 6'-0"

2'-6" TO 3'-0"

3'-0" TO 3'-4"

3'-4" TO 3'- 11"

5'-8" TO 6'-0"

STARBUCKS' AEC WEBSITE.

1/2" ACX PLYWOOD

APPROX. WIDTH

2'-6" BEHIND SINK

MANAGER'S DESK

5'-0" AROUND WC

2'-6" BEHIND SINK

2'-10" BEHIND TABLE

FULL WIDTH OF WALL

BLOCKING SPECIFICATION FOR FRENCH CLEAT MOUNTING SYSTEM

TO BE DETERMINED BY G.C. BASED ON INFORMATION PROVIDED ON

AND DATA RACK

7'-0" CENTERED ABOVE

8'-0" CENTERED ABOVE 3-COMP SINK

DDVV		
1-	<u> </u>	
STANLEY		
YALE	626	
DORMA		
ROCKWOOD		
ROCKWOOD		
GLENN JOHNSON		
CONFALONIER	SILVER	

			. ,	
, / •	INSULATED, TEMPERED GLASS PANEL			
	10" MIN.			
YPE D	· 	TYPE E		TYPE F

DOOR SCHEDULE

36 X 84

36 X 84

36 X 84

36 X 84

SIZE TYPE HARDWARE

DOOR NO. STATUS

EXISTING

NEW

NEW

NEW

DOOR TYPE LEGEND

102

103

104

105

SHEET NOTES

1. GC TO INVESTIGATE EXISTING WALL AND VERIFY IF WALL CAN HOUSE PLUMBING AND BLOCKING. NOTIFY ARCHITECT IF PLUMBING WALL IS REQUIRED.

2. NEW STOREFRONT ENTRY DOOR IN EXISTING STOREFRONT SYSTEM. MODIFY AS NEEDED. MATCH EXISTING TYPE AND FINISH.

FLOOR PLAN NOTES

A. GENERAL CONTRACTOR TO VERIFY ALL DIMENSIONS AND NOTIFY STARBUCKS CONSTRUCTION MANAGER OF ANY DISCREPANCIES PRIOR TO CONSTRUCTION. ALL DIMENSIONS TO BE TAKEN FROM DESIGNATED DATUM POINT.

B. IF EXISTING EXTERIOR ENTRANCE THRESHOLD EXCEEDS REQUIRED AMERICAN'S WITH DISABILITY ACT (ADA) MAXIMUM HEIGHT OF 1/2" (10MM), REMOVE AND REPLACE WITH ACCESSIBLE THRESHOLD. RAISED THRESHOLDS AND FLOOR LEVEL CHANGES AT ACCESSIBLE DOORWAYS TO BE BEVELED WITH A SLOPE NO GREATER THAN 1:12.

C. GENERAL CONTRACTOR TO PROVIDE FIRE TREATED WOOD STUD BLOCKING, OR EQUIVALENT TO SUPPORT ANY WALL ATTACHMENT AND/OR SIGNAGE.

D. ALL DOORS TO PROVIDE 34" (900MM) MINIMUM CLEAR OPENING WHEN OPENED TO 90 DEGREE POSITION UNLESS OTHERWISE NOTED.

E. VERIFY ALL EXISTING DOORS, HARDWARE AND FRAMES MEET STARBUCKS AND/OR CODE REQUIREMENTS.

F. INSTALL 1/4" (6MM) GREEN BOARD ON BACKBAR WALL PER SPECIFICATION.

WALL TYPES

(2) EXISTING DEMISING WALL

(1) EXISTING WALL

3 NEW PARTITION WALL TO STRUCTURE

362S125-33 METAL STUDS 16" O.C. WITH 5/8" TYPE "X" GWB ON BOTH SIDES TO STRUCTURE ABOVE. DRYWALL SCREWS @ 12" O.C. SECURE BOTTOM TRACK TO SLAB WITH 0.145" DIA. POWDER DRIVEN ANCHORS AT 24" O.C. MAX. WITH MIN. 1/2" EMBED. SECURE TOP TRACK TO STRUCTURE AT 24" O.C. MAX. SIZE FASTENERS TO NOT PENETRATE ROOF VAPOR BARRIER.

NEW PARTITION WALL TO 6" ABOVE CEILING

362S125-43 METAL STUDS 12" O.C. WITH 5/8" TYPE "X" GWB ON ONE OR BOTH SIDES TO MINIMUM OF 6" ABOVE CEILING GRID. DRYWALL SCREWS @ 10" O.C. AT PANEL EDGES AND 12" O.C. AT INTERMEDIATE SUPPORTS. 45 DEGREES METAL STUD REINFORCEMENT @ 48" O.C. ABOVE CEILING LINE TO SRUCTURE

NEW FURRED WALL TO 6" ABOVE CEILING

362S125-33 METAL STUDS 16" O.C. WITH 5/8" TYPE "X" GWB TO MINIMUM OF 6" ABOVE CEILING GRID. DRYWALL SCREWS @ 12" O.C., 45 DEGREE METAL STUD REINFORCEMENT @ 48" O.C. ABOVE CEILING LINE TO STRUCTURE ABOVE.

(6) NEW PLUMBING WALL TO STRUCTURE

600S125-33 METAL STUDS 16" O.C. WITH 5/8" MOISTURE RESISTAN GYPSUM BOARD ON BOTH SIDES TO STRUCTURE ABOVE. SECURE MOISTURE RESISTANT GYPSUM BOARD TO STUDS WITH DRYWALL SCREWS AT 10" O.C. AT PANEL EDGES AND 12" O.C. AT INTERMEDIATE SUPPORTS. SECURE BOTTOM TRACK TO SLAB WITH 0.145" DIA. POWDER DRIVEN ANCHORS AT 24" O.C. MAX. WITH MIN. 1/2" EMBED. SECURE TOP TRACK TO STRUCTURE AT 24" O.C. MAX.

ALL GLAZING UNITS TO BE 1" INSULATED DOUBLE GLAZED UNITS

STOREFRONT WINDOW SYSTEM: MAX U-FACTOR = 0.77 MAX RSHG = 0.61


MAX U-FACTOR = 0.70 MAX RSHG = 0.61 MAX AIR INFILTRATION RATE = 1.00 CFM/SF

ENERGY CODE NOTES

WALL LEGEND - FLOOR PLAN

NEW FULL HEIGHT WALL

EXISTING WALL

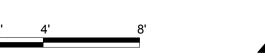



EXISTING WALL



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Revision Schedule

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Description

Store #: 20170 Project # 55066-003 MCS Concept: Palette:

4/10/14

ANDREW HUMAYDAN

A. HUMAYDEN

FLOOR PLAN

As indicated


Issue Date: Design Manager: LEED® AP:

Production Designer Checked by:

Sheet Title:

Sheet Number:

I-1103

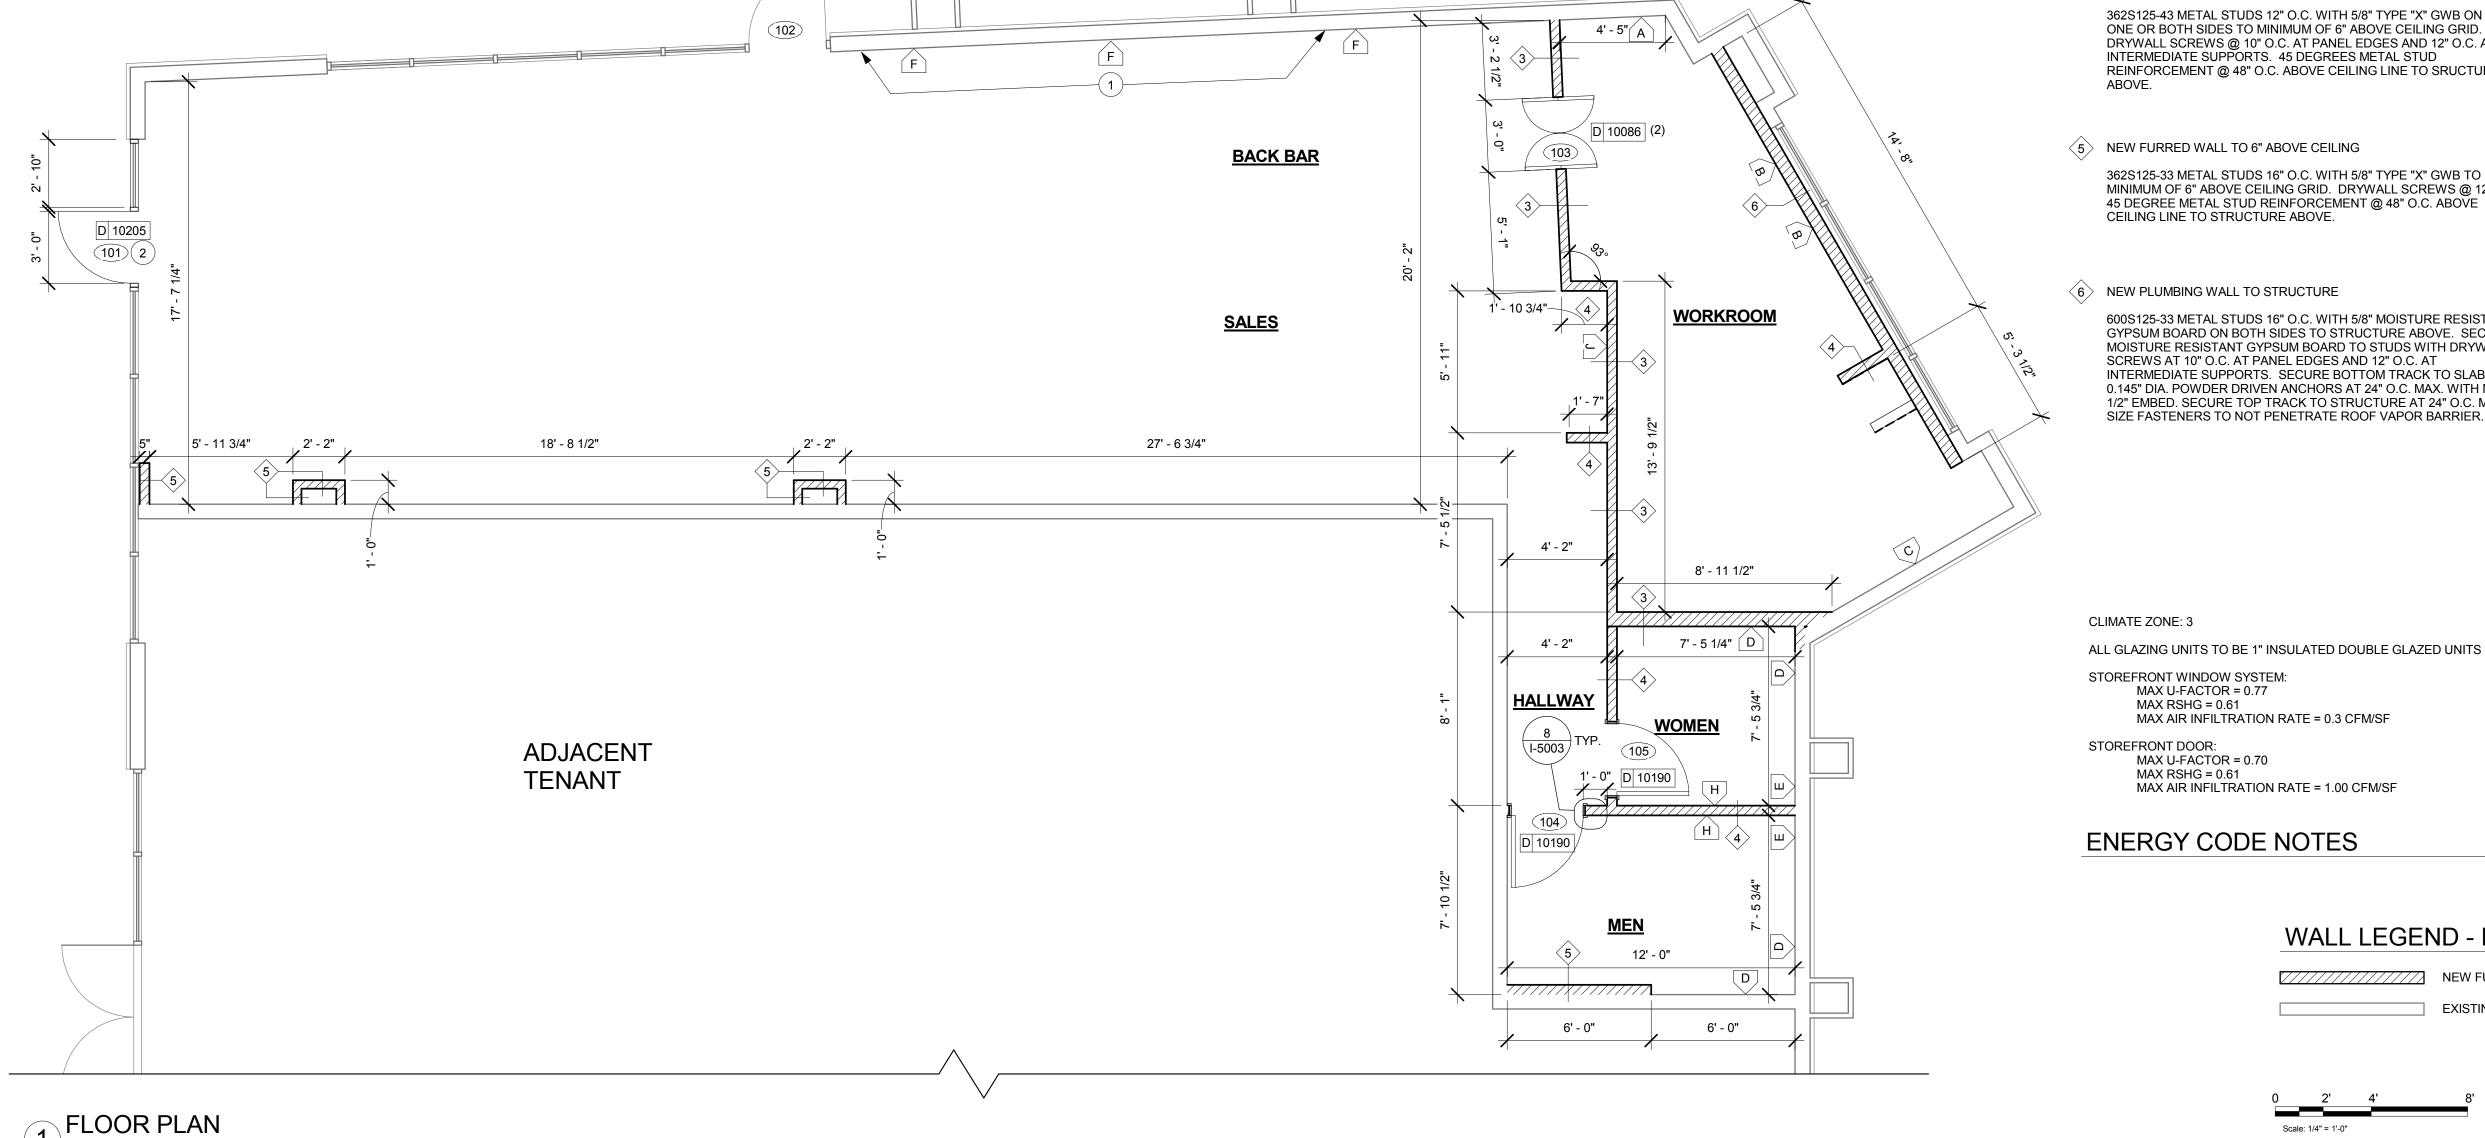

FLOOR PLAN

Scale: 1/4" = 1'-0"

STOP

SYMBOL

D

SILENCERS

COAT HOOK

ITEM

WORKROOM HAND SINK

SHELVES AND DATA RACK

AT MANAGERS DESK

RESTROOM GRAB BARS

RESTROOM HAND SINK

CABINETS AT BACKBAR

UPPER STORAGE (CUBBY)

DIAPER CHANGING TABLE

WALL BLOCKING KEY

MERCH BAYS (STORAGE CABINETS)

SHELVES ABOVE 3-COMP SINK

ROC473 DOOR STOP W/ HOOK

PA00271 COAT HOOK (RESTROOM DOORS ONLY)

WEIGHT

125 LBS

200 LBS

300 LBS

200 LBS

200 LBS

250 LBS

300 LBS

GJ46 RUBBER SILENCER

SHEET NOTES

1. NEW FLOOR SINK. SEE PLUMBING DRAWINGS. 2. NEW ELECTRICAL/DATA PENETRATION. SEE ELECTRICAL DRAWINGS.

3. NEW PLUMBING PENETRATION. SEE PLUMBING DRAWINGS.

PENETRATION PLAN NOTES

A. ALL STUB-UP DIMENSIONS ARE RELATIVE TO FINISHED WALL LOCATIONS (SHOWN AS OUTLINES ON THIS PLAN). REFER TO FLOOR PLAN FOR WALL PLACEMENT.

B. FLOOR SINK: REFER TO CUT SHEETS FOR COMPONENT SPECIFICATIONS AND CUTOUT REQUIREMENTS.

C. WASTE LINE PENETRATIONS: REFER TO PLUMBING PLANS FOR INDIVIDUAL LINE SPECIFICATIONS.

D. STUB-UP PENETRATIONS: REFER TO PLUMBING PLANS FOR INDIVIDUAL STUB-UP SPECIFICATIONS.

E. TOILET FLOOR PENETRATION: REFER TO CUT SHEETS FOR STUB-UP LOCATION RELATIVE TO FINISHED WALL. F. PENETRATION TO BE LOCATED ON CENTERLINE OF WALL

OR AS REQUIRED PER CONDITIONS.

G. TRENCHING OUTLINE FOR GUIDELINE USE ONLY. GENERAL

CONTRACTOR TO COORDINATE WITH SPECIFIC TRADES AND SITE CONDITIONS TO DETERMINE ACTUAL LAYOUT.



Project #: Concept: Palette:

Store #:

Issue Date: Design Manager: LEED® AP:

PENETRATION PLAN

Starbucks Coffee

Company

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Seattle, Washington 98134

(206) 318-1575

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> > Revision Schedule

Description

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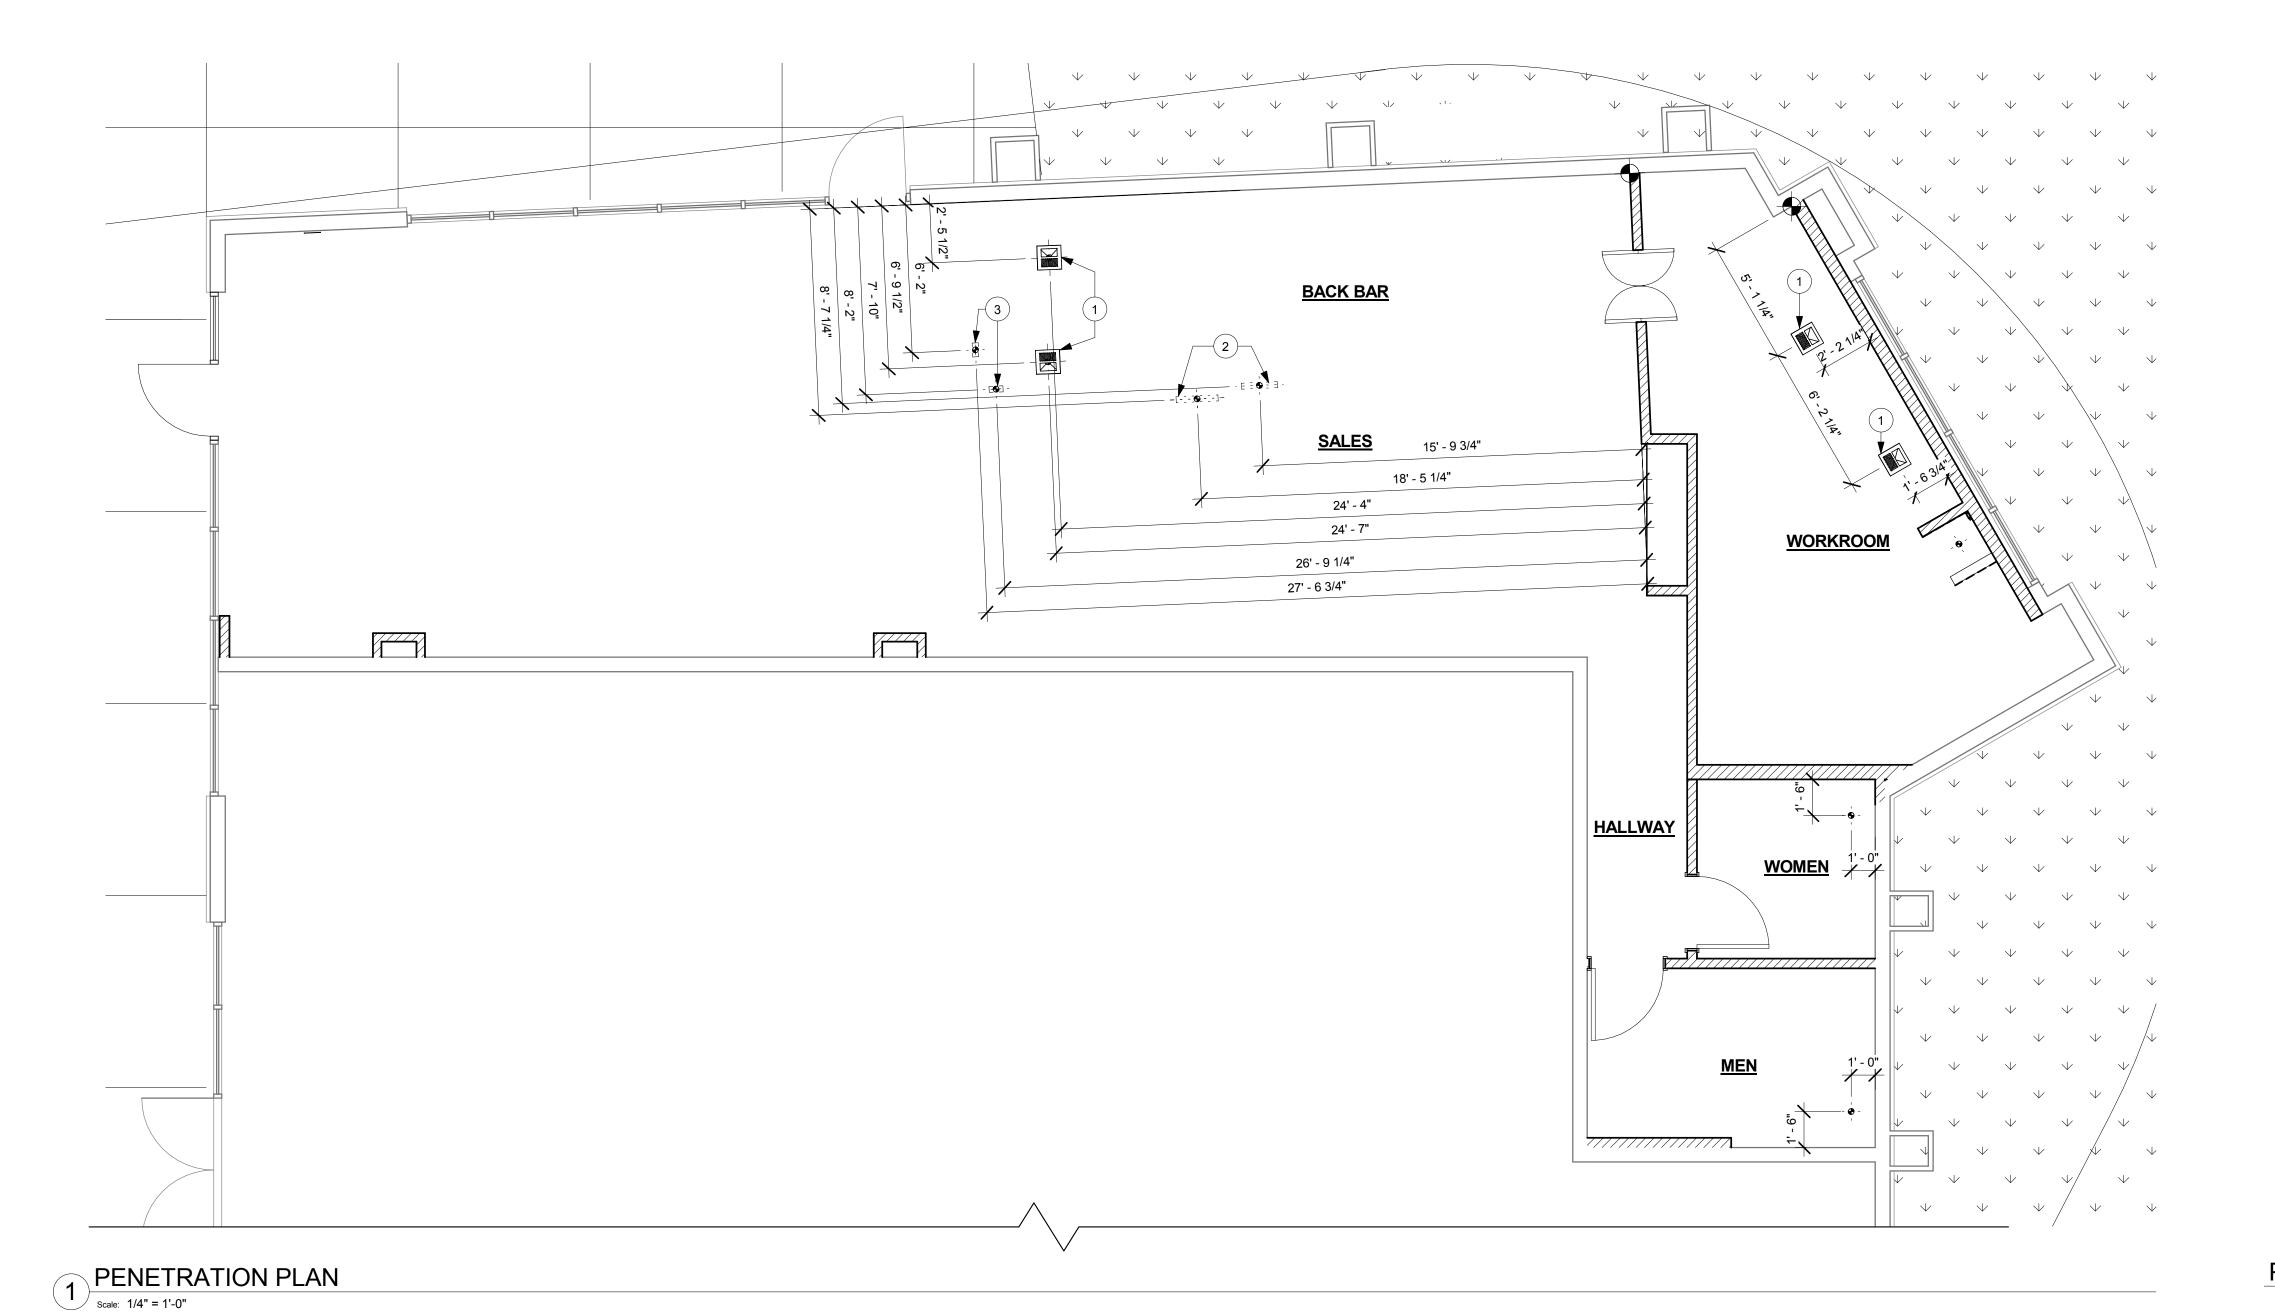
Sheet Number:

I-1104

55066-003

A. HUMAYDEN

1/4" = 1'-0"



PENETRATION PLAN LEGEND

FLOOR SINK

FLOOR PENETRATION

PLUMBING PENETRATION AREA

ELECTRICAL PENETRATION AREA





(20) F 12146

(8) F 10513

← C 12640

(2) F 12379 – (4) F 12330 (1)(7)

PROMOTIONAL BANNER STAND

(14)F 13357 -

Y 12147 (5)

F 12160 (2)

OUTDOOR SEATING

F 12707 (3)

F 12373

1 FURNITURE, FIXTURES, AND EQUIPMENT PLAN

| Scale: 1/4" = 1'-0"

F 12708 (2)

F 12373 (3)

10065 (5)

SHEET NOTES

- 1. INSTALL NEW CAFE FURNITURE THROUGHOUT AS SCHEDULED.
- 2. INSTALL NEW EXTERIOR FURNITURE AS SCHEDULED.
- 3. SECURE LOCKERS TO WALL.

E 10344

F 12212 (5)

F x0105 (5)

(10) |F| 13369 |

E 12508 (2)

(2) Y 10042 -

E 10527

(2) E 10473

(4) FX12334

F x12271

FLOOR

FLOOR

CLR

F X0107

F X0108

- 4. PLACE FIRE EXTINGUISHER IN WORKROOM PER FIRE INSPECTOR.
- 5. LOCATION OF ALL SWITCHING. SEE ELECTRICAL.6. SPEAKERS TO BE MOUNTED AT MXIMUM HEIGHT

PER CUTSHEET. SEE REFLECTED CEILING PLAN FOR

- TAGGING.

 7. GENERAL CONTRACTOR TO COORDINATE
 NEWSPAPER FIXTURE ORDERING. CONTACT TRIAD
 MANUFACTURING BY EMAIL
 (starbuckscs@triadmfg.com) OR BY PHONE (314-381-
- FIXTURE. ALLOW (5) DAY LEAD-TIME.

 8. GENERAL CONTRACTOR TO CAULK WHERE COUNTERTOPS MEET FOOD CASE. SEAL WITH

HEALTH DEPARTMENT APPROVED CAULKING.

(2) E 10312

(2) E 10856

E 10977

E 11115

(2) A 10003

(4) A 10029

• -- •

(2) A 10014 9

E 10314

E 10724

∃ 10305

E 10746

∃ 10856

E 10091 E 10791 (2)

E 10858 E 13330

E 13584

A 10028

F X1967 (3)

E 10396 E 10855 (2) (2)E 12407

5280 X1111) TO ARRANGE SHIPMENT OF THE

9. STARBUCKS CONTRACTS DIRECTLY WITH A DATA CABLING VENDOR TO SUPPLY AND INSTALL CAT5 LAN CABLING FOR THEIR POS SYSTEM.
CONTRACTOR MUST SCHEDULE THROUGH THE STARBUCKS CM A MINIMUM OF TWO WEEKS PRIOR TO NEED.

TO CONTACT AN INFORMATION TECHNOLOGY (IT) VENDOR REGARDING DATA, CABLING, VOICE AND NETWORK CIRCUITS, IT RACK AND/OR TURNING EQUIPMENT OFF FOR RELOCATION OR PAINTING. CONTACT VIA EMAIL: newstore@starbucks.com

ANY ADDITIONAL EXPENSES INCURRED DUE TO CONTRACTOR'S FAILURE TO SCHEDULE ACCORDINGLY WILL BE THE RESPONSIBILITY OF THE CONTRACTOR.

BACK BAR

HALLWAY

10 I-4102

FF AND E PLAN NOTES

A. GENERAL CONTRACTOR TO SCHEDULE WITH LOCAL REFRIGERATION CONTRACTOR TO CONDUCT INITIAL FOOD CASE START-UP AND TESTING. FOR APPROVED CONTRACTOR, CONTACT VENDOR.

B. THE SPACE IS SERVED BY THE MUNICIPAL WATER AND SEWER SYSTEM UNLESS OTHERWISE NOTED.

C. ALL EQUIPMENT AND INSTALLATION WILL MEET NATIONAL SANITATION FOUNDATION STANDARDS OR EQUIVALENT.

D. EQUIPMENT UNITS SHALL CONTAIN NO EXPOSED THREADS, EMBELLISHMENTS OR OVERHANGING EDGES THAT SERVE AS PLACES FOR ACCUMULATION OF DUST, DIRT AND DEBRIS.

E. WARMING OVEN(S) SHOWN FOR PERMITTING PURPOSES. INSTALLATION AT STORE OPENING TO BE VERIFIED BY STARBUCKS CONSTRUCTION REPRESENTATIVE.

F. EACH HAND WASHING SINK WILL HAVE A SINGLE SERVICE TOWEL AND SOAP DISPENSER, AND ALL HAND SINKS TO HAVE A COMBINATION FAUCET OR PREMIXING FAUCET.

G. FOR PLUMBING FIXTURES, REFER TO THE PLUMBING DESIGN PLAN. FOR DATA DEVICE SCHEDULE, REFER TO THE ELECTRICAL DESIGN PLAN

E 11104

E 10293

E 10880

10648

E 11115

E 10769

E 10862

E 13578

A 10004 A 10007

A 10011 A 10019

E 10947

E 10462 (5)

E 10416 (5)

WORKROOM

A 10000 A 10005

/-E|10501 (4 .



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Revision Schedule

Date By Description

Rev Date By Description

& SARATOGA
sss:
ATOGA AVE
SE, CA 95129
C: SANTA CLARA COUNTY

Store #: 20170
Project #: 55066-003

Concept:
Palette:
Issue Date:

Issue Date:

Design Manager:

LEED® AP:

Production Des

oduction Designer:
necked by:
A. HUMAYDEN

Sheet Title

FF AND E PLAN

Sheet Number:

I-1105

1/4" = 1'-0"

0 2' 4' 8'
Scale: 1/4" = 1'-0"

SHEET NOTES

- 1. DO NOT CAULK TRASH RINGS TO COUNTERTOPS.
- 2. GC TO CUT DIE WALL, PANELS AND TOP CAP IN FIELD
- 3. INSTALL NEW UPPER CUBBIES WITH CONTINUOUS LIGHT VALANCE AT BACK LINE CUBBIES. PROVIDE 2X WOOD BLOCKING. SEE ELEVATIONS. SEE ELECTRICAL FOR UNDER CABINET TASK LIGHTING.
- 4. COORDINATE CASEWORK INSTALLATION WITH MEP. SEE CASEWORK DETAILS.
- 5. CHAIR RAIL AS SCHEDULED, SEE WALL FINISH PLAN, ELEVATIONS, AND SCHEDULES.
- 6. FEATURE CUBES AND RETAIL FLOOR BASKETS, PLACE PER PLAN. STORE OPERATIONS TO ORDER RETAIL FLOOR BASKET.
- 7. SECURE MERCH BAYS TO WALL AT TOP OF CABINETS WITH CONTINUOUS METAL ANGLE FASTENED TO WALL
- 9. CUSTOM BUILT QUEUE RAILING. VENDOR TO PROVIDE, GC TO INSTALL.
- 10. VARIABLE WIDTH FILLER CABINET. VIF WIDTH REQUIRED.

CASEWORK PLAN NOTES

- A. GENERAL CONTRACTOR TO NOTIFY STARBUCKS CONSTRUCTION MANAGER IMMEDIATELY IF A DISCREPANCY EXISTS BETWEEN CASEWORK SHOP DRAWINGS, SITE DIMENSIONS, CASEWORK PLAN OR ACTUAL CASEWORK FIXTURES. ALL DIMENSIONS TO BE TAKEN FROM DESIGNATED DATUM POINT.
- B. STARBUCKS CONSTRUCTION MANAGER TO COORDINATE AND SCHEDULE CASEWORK DELIVERY DATE. GENERAL CONTRACTOR TO CONFIRM CASEWORK DELIVERY DATE WITH CASEWORK MANUFACTURER 4 WEEKS AND 1 WEEK PRIOR TO SCHEDULED DATE OF DELIVERY.
- C. STARBUCKS CONTRACTS DIRECTLY WITH CASEWORK VENDOR TO SUPPLY CASEWORK LISTED IN CASEWORK SCHEDULE, UNLESS OTHERWISE NOTED.
- D. REFER TO CASEWORK INSTALLATION MANUAL PROVIDED BY CASEWORK VENDOR FOR COMPLETE INSTALLATION INSTRUCTIONS.
- E. ALL CASEWORK BASE UNITS SHALL BE SET ON 1/4" (6MM) NON-ABSORBENT PLASTIC SHIMS PROVIDED BY CASEWORK
- F. SEE WALL FINISH PLAN FOR LOCATION, TAGGING, AND FINISH SCHEDULES OF APPLIED WALL TREATMENTS.
- G. SEE REFLECTED CEILING PLAN FOR CASEWORK SOFFIT LOCATIONS.



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	Revision Schedule					
tev Date By Description						
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Store #: 55066-003 Project #

Concept: Palette: Issue Date:

Design Manager: LEED® AP:

Production Designer


CASEWORK PLAN

A. HUMAYDEN

1/4" = 1'-0"

Sheet Number:

I-1107

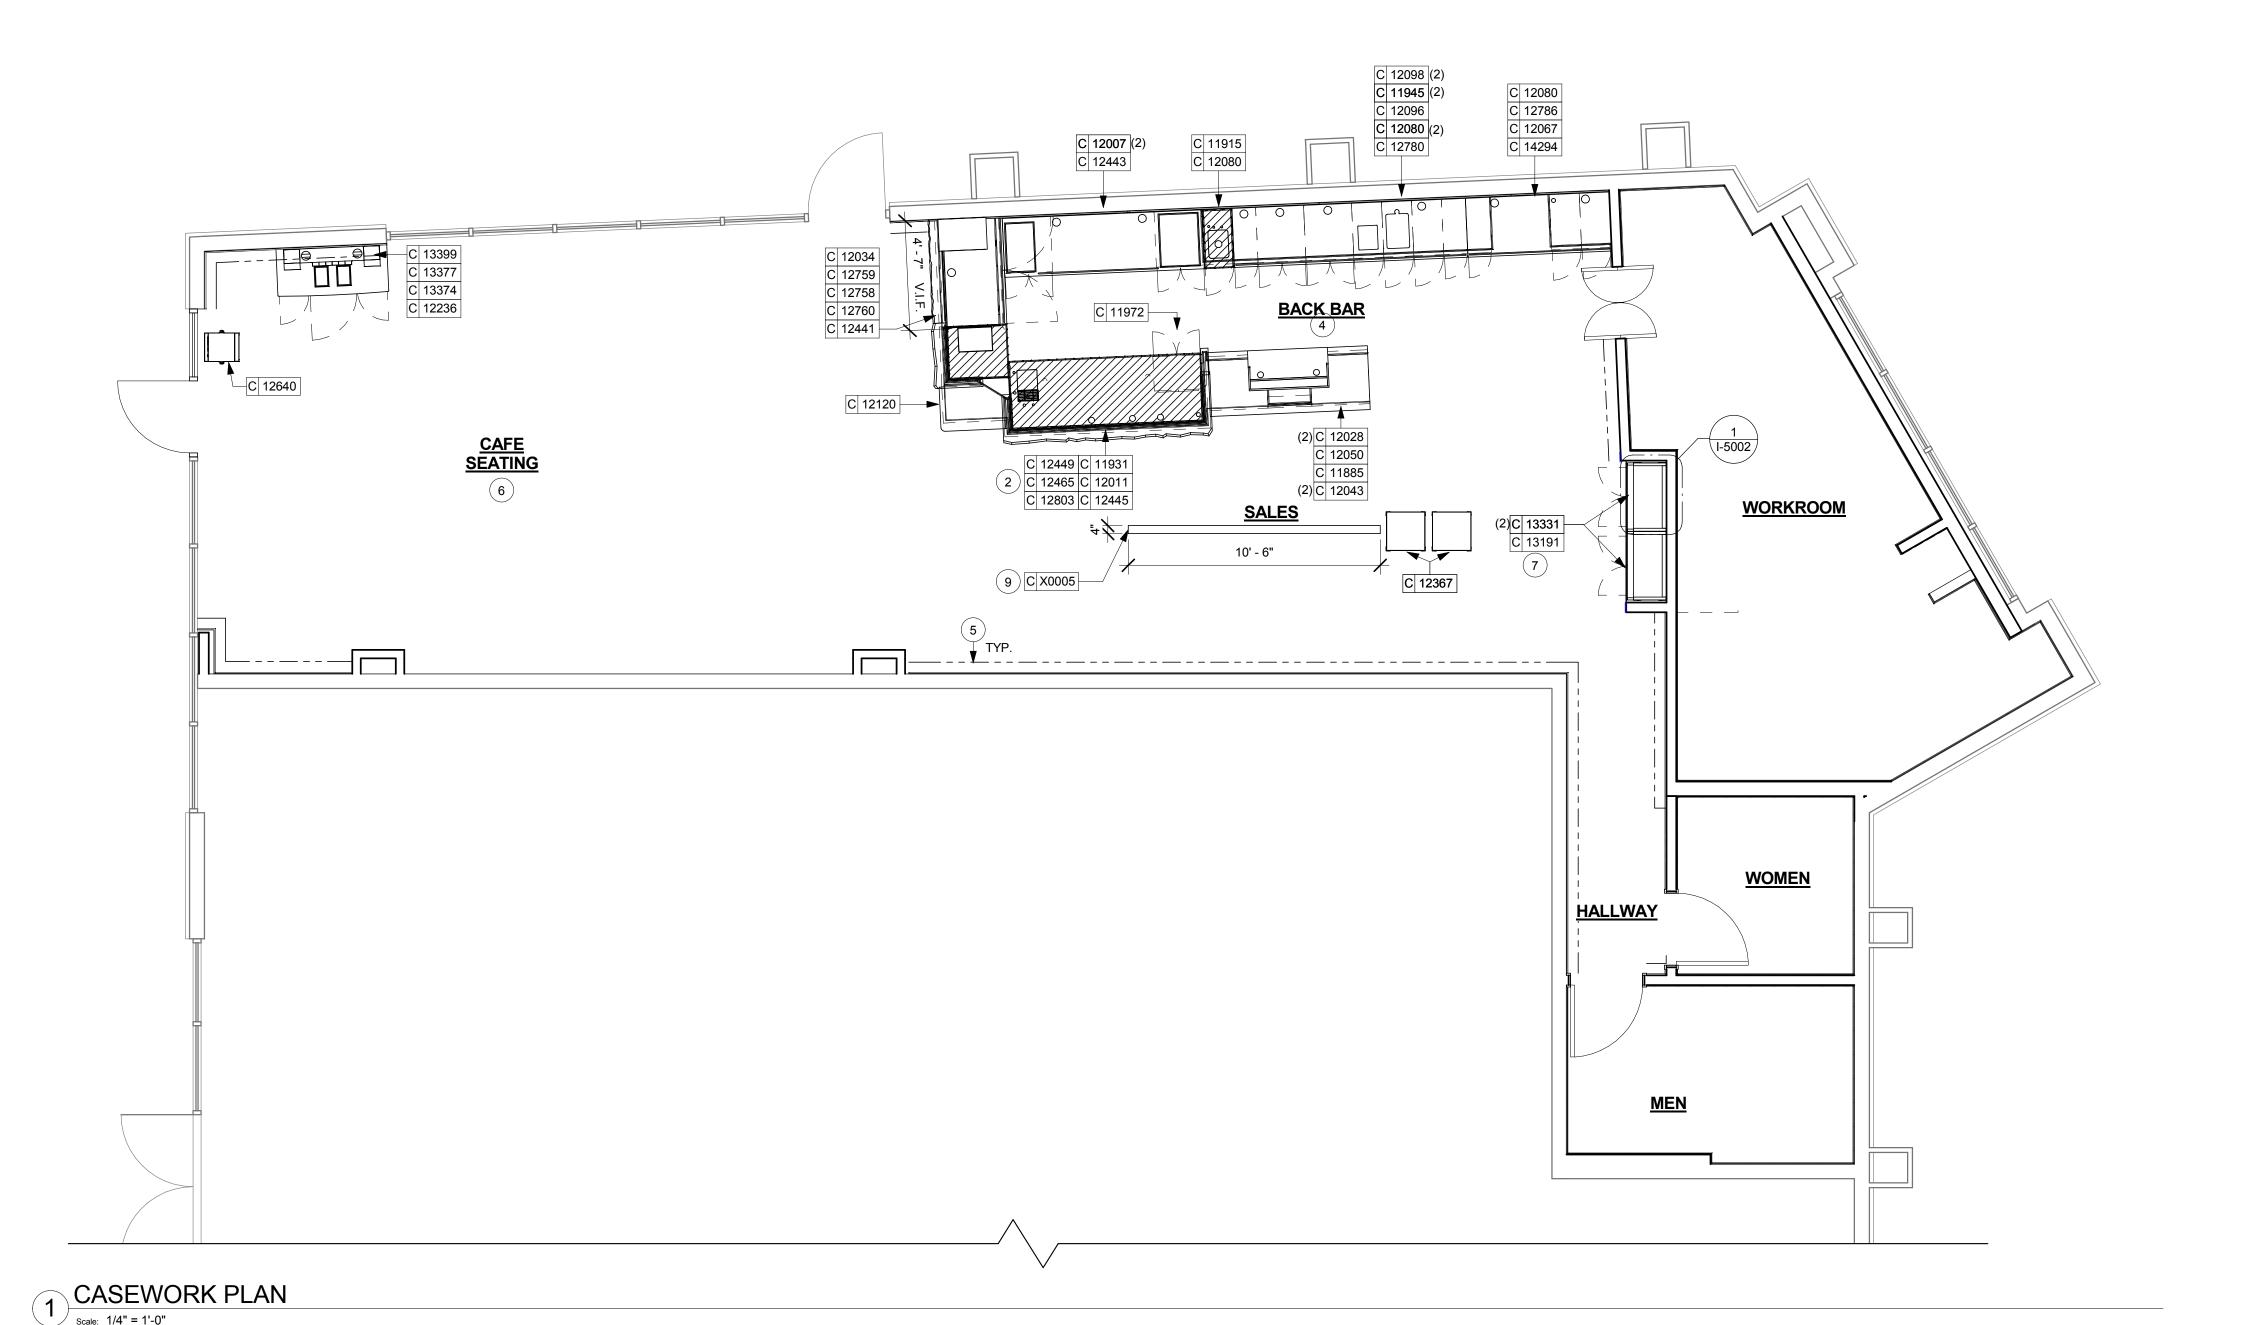

CASEWORK PLAN LEGEND

— - - — INDICATES CHAIR RAIL

INDICATES STAINLESS STEEL (SST) COUNTERTOP

INDICATES SOLID SURFACE (SS) COUNTERTOP

SHEET NOTES

- 1. NEW DECORATIVE PENDANT ABOVE COMMUNITY
- 2. INSTALL (14) NEW RECESSED CAN LIGHT FIXTURES AT
- 3. INSTALL (15) NEW RECESSED CAN LIGHT FIXTURES AT
- NEW ACT CEILING AT CAFE SEATING, PAINT TRIM TO
- 7. ADJUST FOCUS OF ALL TRACK AND RECESSED DIRECTIONAL LIGHTING TO FULLY ILLUMINATE ALL
- 8. NEW SHAPE AT BAR SOFFIT. PAINT GWB SOFFIT ABOVE BAR, INCLUDING LIGHTING TRIM AND HVAC METAL
- 9. PAINT ACOUSTICAL CEILING TILE THROUGHOUT CAFE.
- ACOUSTIC TILE AT WORKROOM AT 10'-0" AFF.
- WORKROOM.
- 12. INSTALL NEW RESTROOM LIGHT FIXTURE ABOVE MIRROR. SEE ELEVATIONS.
- 13. PAINT RESTROOM GWB CEILING AND WALLS ABOVE

- TABLE. SUSPEND BOTTOM OF PENDANT AT 7'-6" AFF.
- NEW GWB SOFFIT OVER BACKBAR, SEE ELECTRICAL.
- NEW GWB SOFFIT OVER CAFE SEATING, HALLWAY, AND RESTROOM, SEE ELECTRICAL.
- 4. INSTALL (19) NEW RECESSED CAN LIGHT FIXTURE AT MATCH CEILING, SEE ELECTRICAL.
- 5. INSTALL (13) NEW UNDER CUBBY LIGHTING WITH CONTINUOUS VALANCE. LOCATE POWER SUPPLY ABOVE CEILING, PROVIDE J-BOX, CONDUIT AND CONDUCTORS TO CONNECT TO LIGHTING CCT SERVING THE AREA.
- 6. INSTALL (1) NEW 12' TRACK WITH (12) TRACK HEADS AS SHOWN. SURFACE-MOUNT TRACK DIRECTLY TO SOFFIT, SEE ELECTRICAL.
- ARTWORK, MENU BOARDS AND MERCH BAYS.
- GRILL. PAINT ALL SIDES SAME COLOR.
- 10. INSTALL NEW SUSPENDED CEILING GRID AND
- 11. VINYL FACED CEILING TILES (T001) REQUIRED AT

14. INSTALL EXIT SIGNAGE CENTERED OVER NEW DOOR.

I-5003/

WORKROOM

X9003-SG GWB SOFFIT 10'-0" AFF

X9004 GWB SOFFIT 10'-0" AFF

REFLECTED **CEILING PLAN NOTES**

A. IF REQUIRED BY LOCAL CODE, GENERAL CONTRACTOR TO PROVIDE SEMI-RECESSED SPRINKLER HEADS WITH POLISHED CHROME ESCUTCHEONS CENTERED IN ACOUSTICAL CEILING TILE. IF PENDANT HEADS ARE REQUIRED IN GYPSUM SOFFIT OVER FRONTBAR, CONCEAL SUPPLY PIPING WITHIN SOFFIT. GENERAL CONTRACTOR TO SUBMIT SPRINKLER LAYOUT TO STARBUCKS' CONSTRUCTION MANAGER FOR APPROVAL PRIOR TO INSTALLATION.

B. GENERAL CONTRACTOR TO PROVIDE AND LOCATE SPRINKLERS PER LOCAL CODES. CONTACT STARBUCKS CONSTRUCTION MANAGER IF DESIGN INTENT IS AFFECTED.

C. WHERE ACOUSTICAL CEILING MEETS WALL, PROVIDE ANGLE WALL MOLDING FOR REVEAL. MATCH CEILING GRID COLOR WHEN APPLICABLE.

D. LEAVE (10) ADDITIONAL RETAIL CEILING TILES, TO MATCH RETAIL CEILING PAINT COLOR, ABOVE THE WORKROOM CEILING AT MANAGER'S DESK FOR FUTURE USE.

E. PROVIDE GROMMET AT ALL CEILING PENETRATIONS FOR FIXTURES OR SUPPORTS.

F. HEATING, VENTILATING, AND AIR CONDITIONING (HVAC) SHOWN FOR DESIGN INTENT ONLY. CONTACT PROJECT MANAGER IF CHANGED.

G. DIFFUSERS AND RETURNS AT BACKBAR IN ACOUSTICAL CEILING TILE TO BE CENTERED IN TILE, PAINTED TO MATCH ADJACENT FINISHES, TYPICAL.

H. PAINT ALL HVAC DUCTS, HVAC DIFFUSERS, RECESSED SPEAKERS AND LIGHT TRIM RINGS THE SAME COLOR AS CEILING OR SOFFIT. TYPICAL THROUGHOUT RETAIL PORTION OF STORE.

J. PAINT SUBSTITUTIONS ARE NOT ALLOWED. USE STARBUCKS' NATIONAL ACCOUNT "COLOR CODE" WHEN ORDERING PAINTS. SEE SCHEDULE SHEETS FOR SCHEDULES

K. SEE LIGHTING DESIGN PLAN FOR FIXTURE TYPES AND LOCATION DIMENSIONS.



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Revision Schedule Description

55066-003

Concept:

Store #:

Design Manager:


LEED® AP:

A. HUMAYDEN

REFLECTED CEILING PLAN

Sheet Number:

I-1108

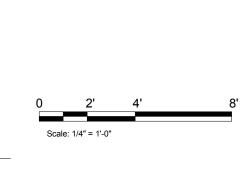

REFLECTED CEILING PLAN

X9004

ACT CEILING 12'-0" AFF

EQ EQ

4' - 0"

X9003-ES GWB SOFFIT 10'-0" AFF

SEATING

ACT CEILING 10'-0" AFF

10'-0" AFF

11/2011 0:16:16 AM

SHEET NOTES

- 1. TILE START POINTS WHERE INDICATED.
- 2. FLOOR SINK/FLOOR DRAIN LOCATION.
- 3. INSTALL NEW FLOOR TILE WHERE INDICATED.
- 4. NEW TILE BASE THROUGHOUT CAFE, BACK BAR, AND WORKROOM.
- 5. INSTALL WALK-OFF MAT AS INDICATED.

FLOOR FINISH PLAN NOTES

A. STARBUCKS TO SUPPLY RETAIL FLOOR TILE AND TILE BASE. GENERAL CONTRACTOR TO INSTALL. GENERAL CONTRACTOR TO SUPPLY WORKROOM TILE AND BASE AND INSTALL. GENERAL CONTRACTOR TO SUPPLY AND INSTALL MORTAR, ADHESIVE, AND GROUT. GENERAL CONTRACTOR TO INSPECT ALL TILES AND REJECT DAMAGED OR SUBSTANDARD TILES PRIOR TO INSTALLATION.


B. ALL TILE AND SLATE TO BE INSTALLED PER TILE COUNCIL OF AMERICA STANDARDS.

C. ALL FLOORING AND BASE MATERIAL TO BE INSTALLED ACCORDING TO STARBUCKS SPECIFICATIONS.

D. CABINET BASES TO BE SET AFTER TILE INSTALLATION.

E. ALIGN TILE TRANSITIONS ON WHOLE TILES AS SHOWN.

F. FOR CARPET INSTALLATION, REFER TO MANUFACTURERS' INSTALLATION INSTRUCTIONS.

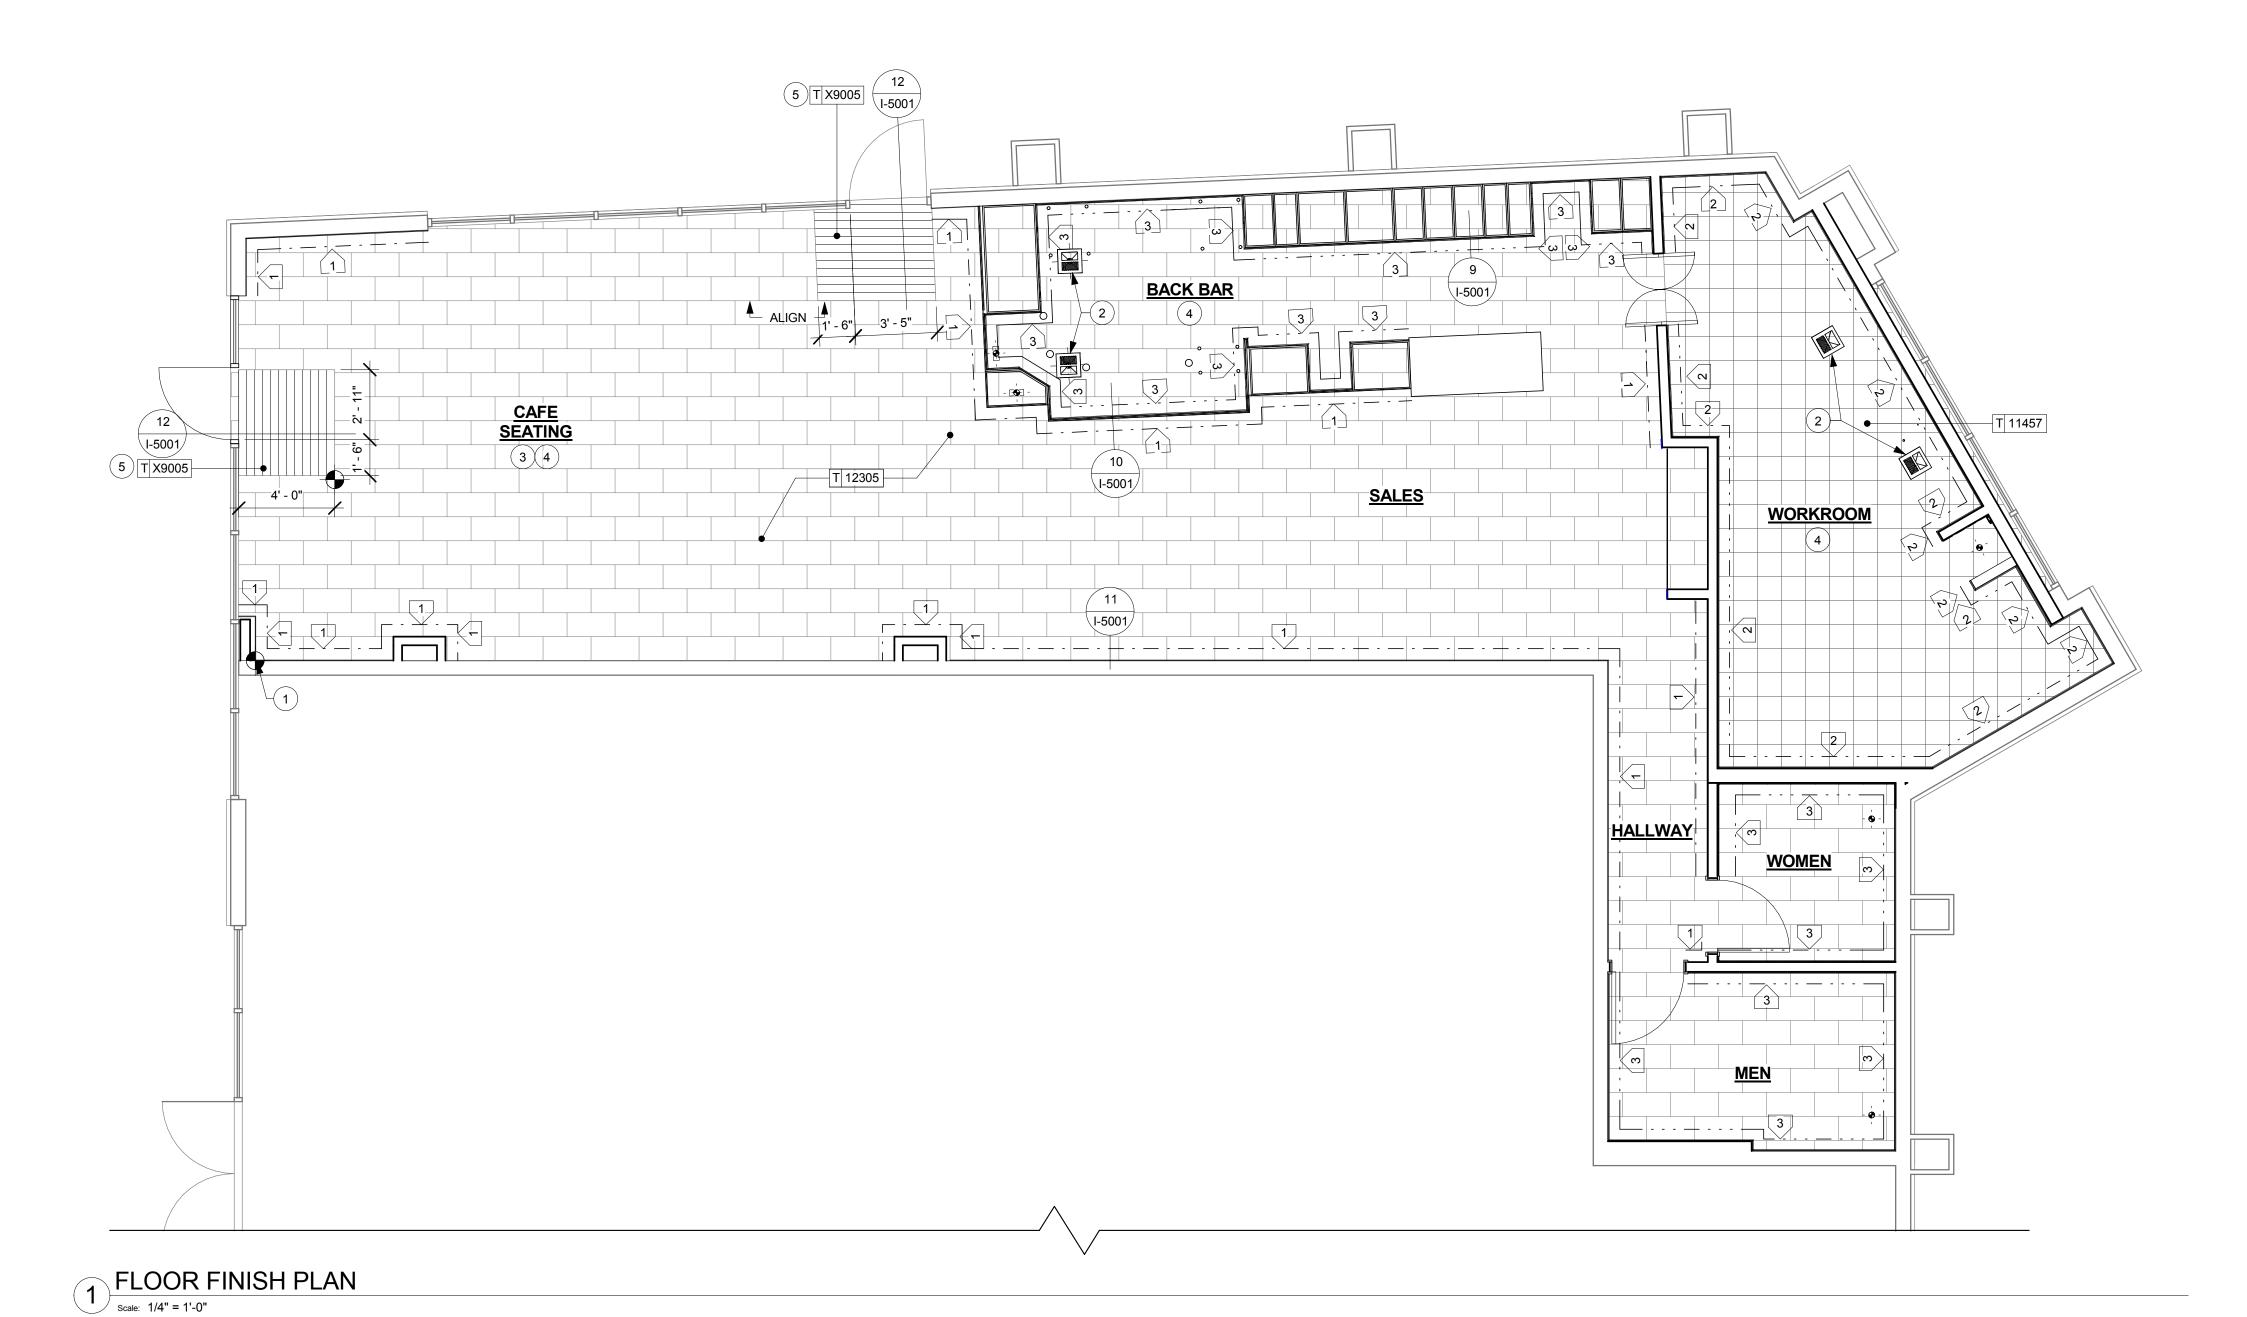

FLOOR LEGEND

1 - - - - CAFE H.R.S. BASE

2 — · · — WORKROOM TILE BASE

3 — - - - BACK BAR & RESTROOM TILE BASE







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Architect of Record SALASO'BRIEN



		Rovis	sion Schedule
Rev	Date	By	Description
			-

A AVE 95129 TA CLARA COUNTY

CIELY & SA Oject Address: 03 SARATOG AN JOSE, CA

Store #: 20170
Project #: 55066-003
Concept: MCS

Palette:
Issue Date:
Design Manager:
LEED® AP:

Production Designe

checked by: A. HUMAYDEN

Sheet Title:

FLOOR FINISH PLAN

I-1109

1/4" = 1'-0"

Sheet Number:

SHEET NOTES

1. FULL HEIGHT FRP AT MOP SINK ENCLOSURE AND ALL WORKROOM WALLS, U.O.N. SEE ELEVATIONS.

2. BACKBAR WALL TILE TO BOTTOM OF UPPER CUBBIES (WHERE THEY OCCUR) REFER TO INTERIOR ELEVATIONS FOR EXTENT OF WORK. REFER TO SCHEDULES FOR MATERIALS.

3. NEW RESTROOM WALL TILE. SEE RESTROOM ELEVATIONS FOR EXTENT OF WORK. REFER TO SCHEDULES FOR MATERIALS.

4. CHAIR RAIL AND VINYL WAINSCOT THROUGHOUT FACE SEATING AND VESTIBULE U.O.N. SEE ELEVATIONS.

5. GREEN GUARD CERTIFIED FRP BELOW COUNTERTOPS AT ALL EXPOSED BACKBAR LOCATIONS.

B. CHANGE OF PAINT COLOR ALLOWED AT INSIDE CORNERS

WALL FINISH PLAN NOTES

LOCATIONS.

D. REFER TO CASEWORK FINISH SCHEDULE FOR ADDITIONAL INFORMATION

E. GENERAL CONTRACTOR TO PROVIDE AND INSTALL WORKROOM WALL FINISHES.



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		Revis	sion Schedule
9V	Date	Ву	Description

lev	Date	Ву	Description
	•		_

Store #: Project #: 55066-003 Concept: Palette: Issue Date:

Design Manager: LEED® AP: Production Designer:

A. HUMAYDEN

WALL FINISH PLAN


1/4" = 1'-0"

Sheet Number: I-1111



REQUIREMENTS.

C. REFER TO INTERIOR ELEVATIONS FOR GRAPHICS

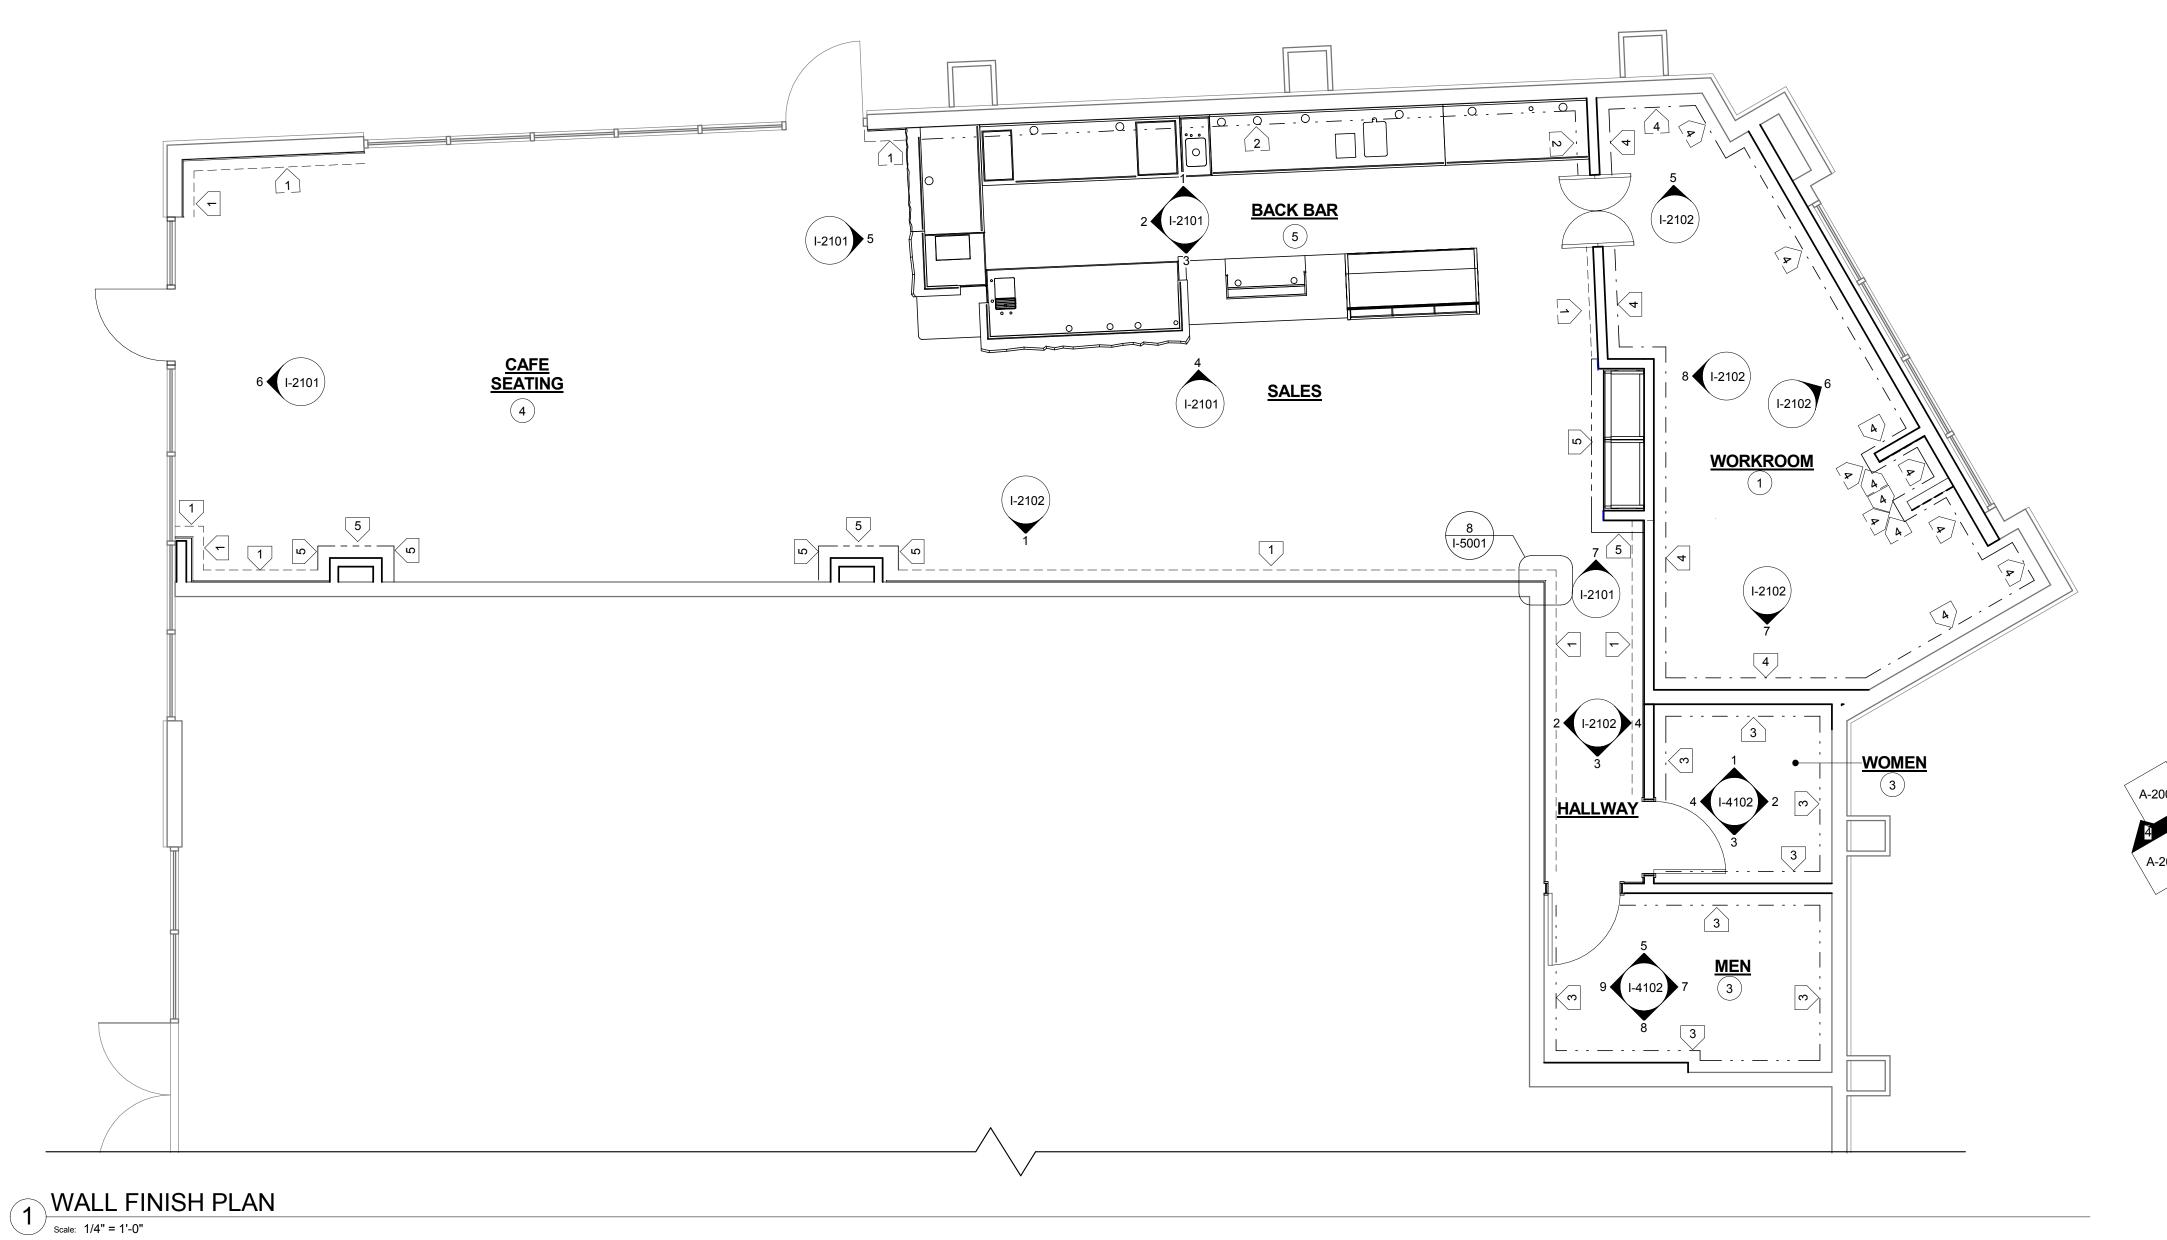

WALL TREATMENT LEGEND

1 ----- INDICATES WAINSCOT — - - - — INDICATES BACKBAR WALL TILE


- — - - — INDICATES RESTROOM WALL TILE

· — · — INDICATES FULL HEIGHT FRP (GREENGUARD CERTIFIED)

5 — - - - — INDICATES FULL HEIGHT WOOD CLADDING





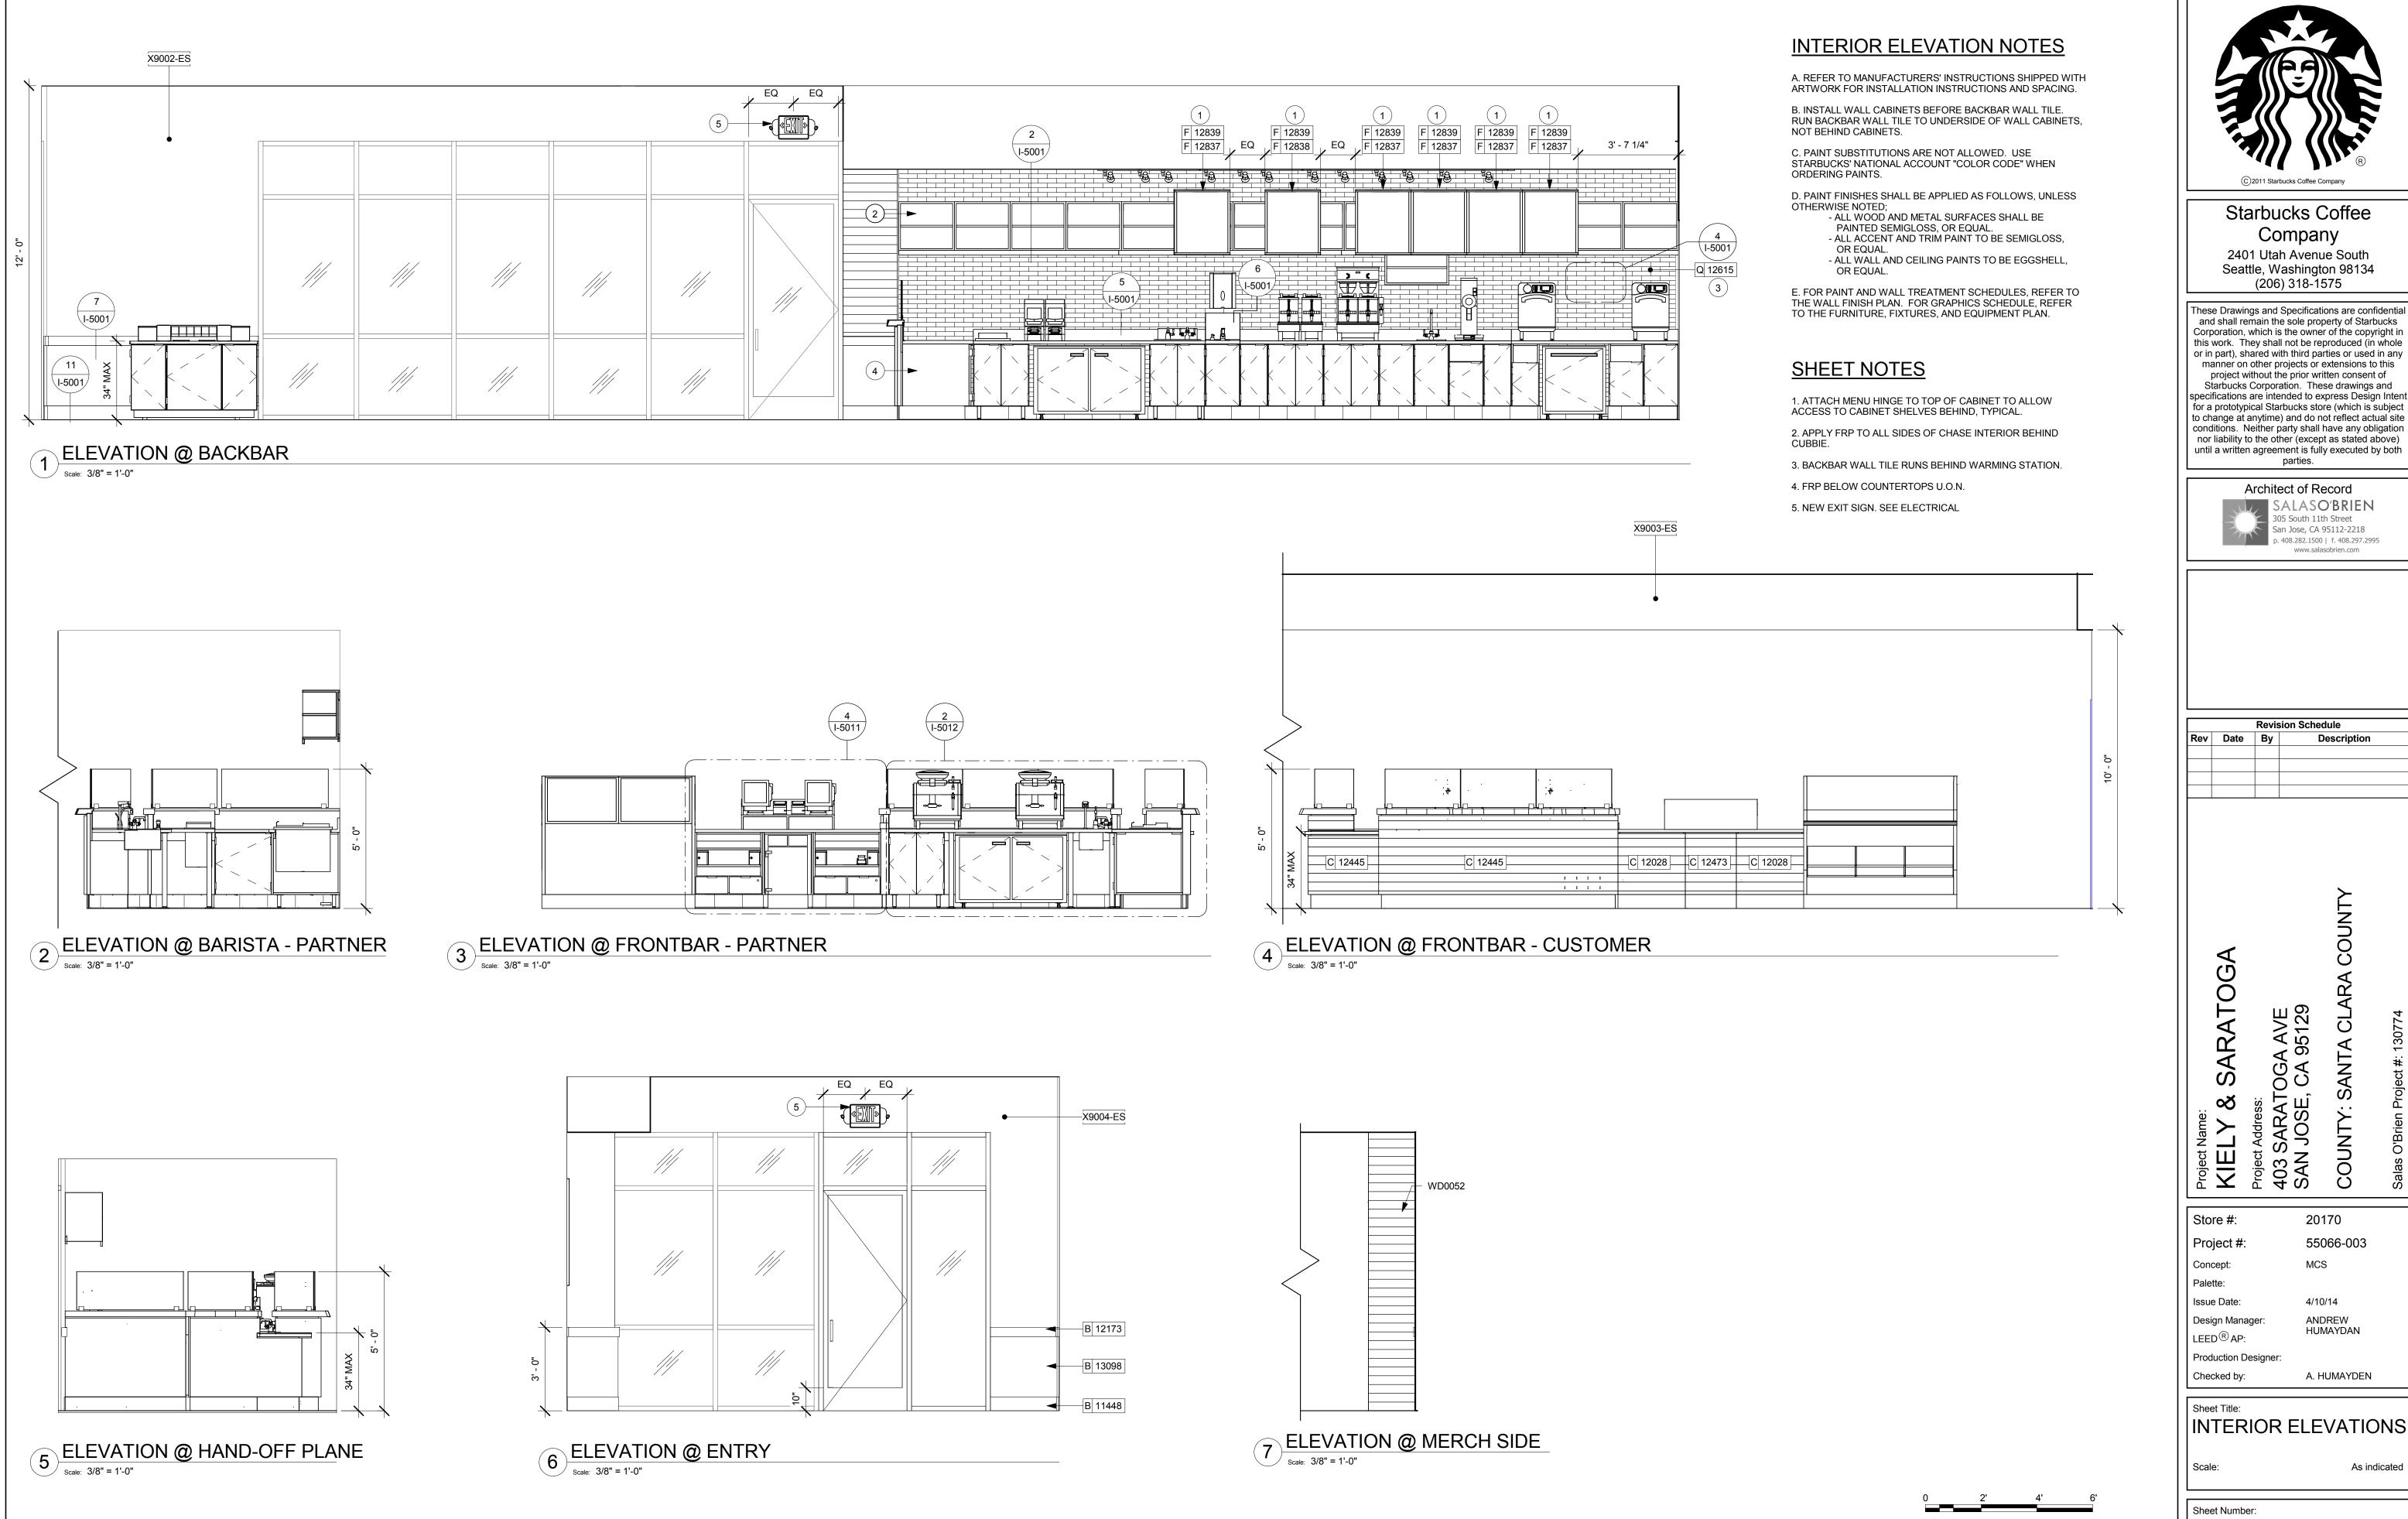



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SALASOBRIEN 305 South 11th Street San Jose, CA 95112-2218 o. 408.282.1500 | f. 408.297.2995 www.salasobrien.com

Revision Schedule Description

SARATOGA Project Name:
KIELY &
Project Address:
403 SARATC

Store #: 55066-003 Project # MCS

Concept: Palette: Issue Date: Design Manager:

LEED® AP: Production Designer


A. HUMAYDEN

INTERIOR ELEVATIONS

As indicated

4/10/14

Sheet Number:

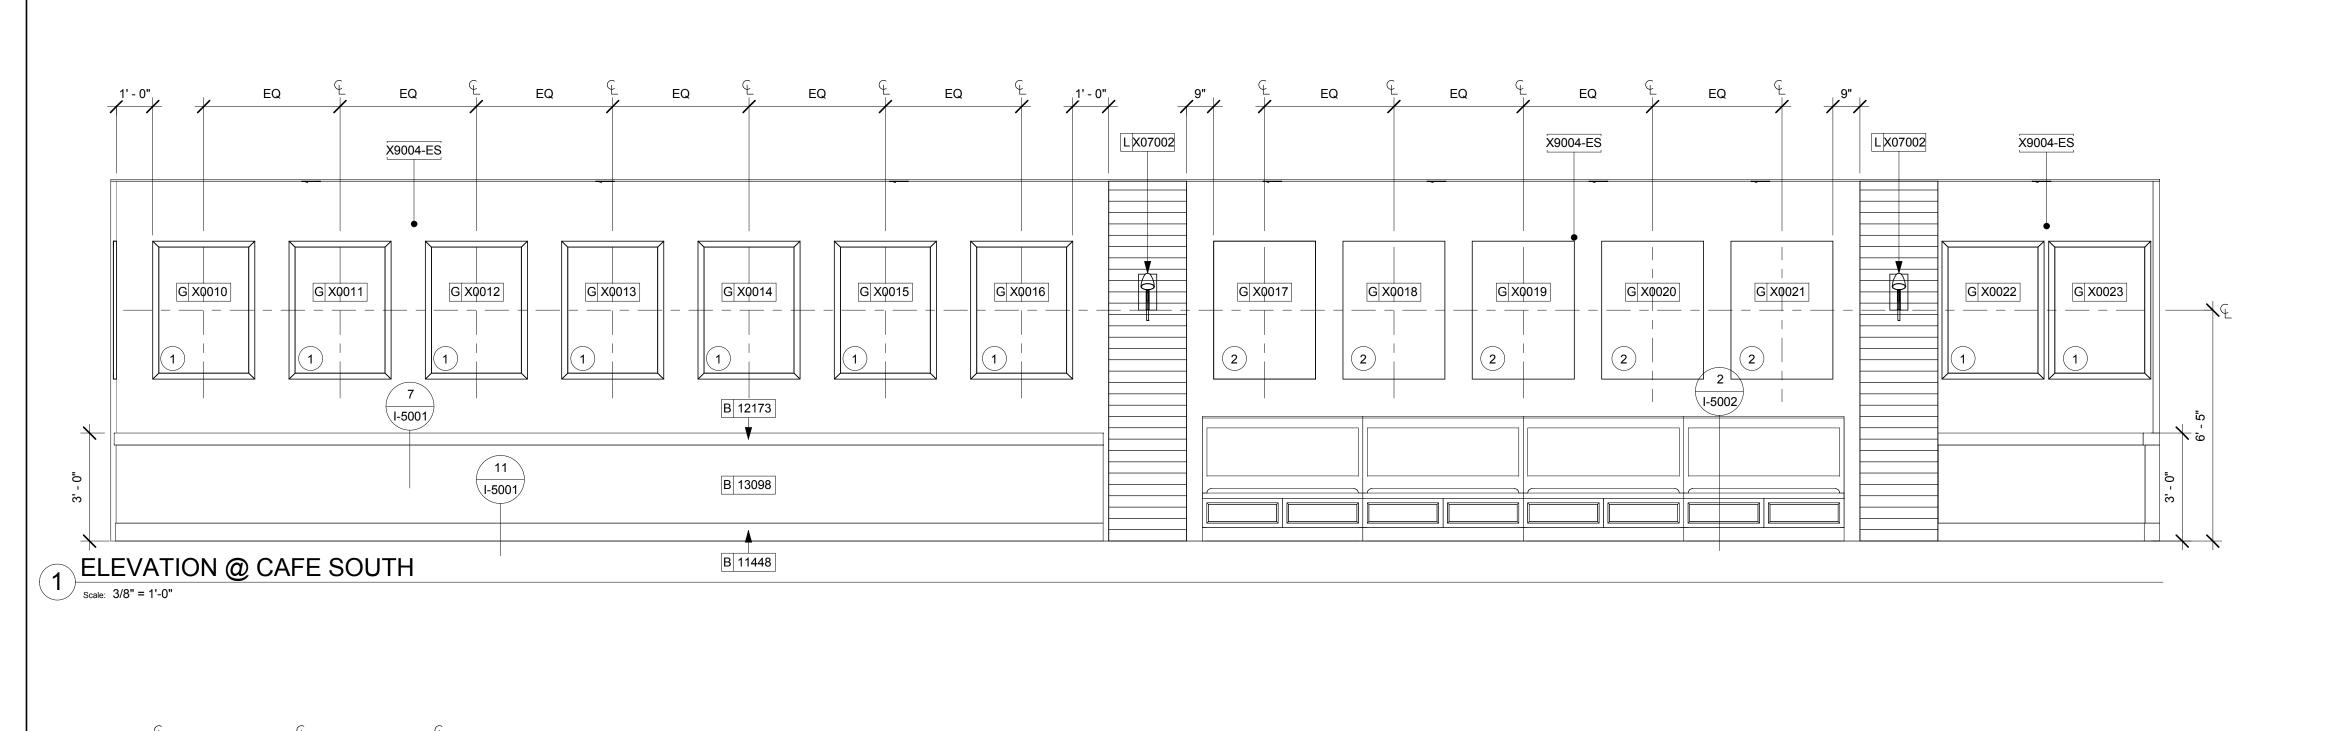



A. REFER TO MANUFACTURERS' INSTRUCTIONS SHIPPED WITH ARTWORK FOR INSTALLATION INSTRUCTIONS AND SPACING.

B. INSTALL WALL CABINETS BEFORE BACKBAR WALL TILE. RUN BACKBAR WALL TILE TO UNDERSIDE OF WALL CABINETS, NOT BEHIND CABINETS.

C. PAINT SUBSTITUTIONS ARE NOT ALLOWED. USE STARBUCKS' NATIONAL ACCOUNT "COLOR CODE" WHEN

D. PAINT FINISHES SHALL BE APPLIED AS FOLLOWS, UNLESS

- OTHERWISE NOTED; - ALL WOOD AND METAL SURFACES SHALL BE
 - PAINTED SEMIGLOSS, OR EQUAL.
 - ALL ACCENT AND TRIM PAINT TO BE SEMIGLOSS, OR EQUAL.
 - ALL WALL AND CEILING PAINTS TO BE EGGSHELL, OR EQUAL.
- E. FOR PAINT AND WALL TREATMENT SCHEDULES, REFER TO THE WALL FINISH PLAN. FOR GRAPHICS SCHEDULE, REFER TO THE FURNITURE, FIXTURES, AND EQUIPMENT PLAN.

SHEET NOTES

ORDERING PAINTS.

- 1. FRAMED ARTWORK 30"x42"
- 2. 30"x42" H.R.S. PLATE.
- 3. FULL HEIGHT FRYP TYPICAL ALL WORKROOM WALLS.
- 4. PLACE FIRE EXTINGUESHER PER FIRE MARSHALL
- 5. LOCATION OF ELECTRICAL PANELS.

Q 11469 (3)

2' - 6 3/4" 7 1/2" 10"



Starbucks Coffee Company

2401 Utah Avenue South Seattle, Washington 98134 (206) 318-1575

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Architect of Record



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Revision Schedule Description

Project Name:
KIELY & SARATOGA

Project Address: 403 SARATOGA AVE SAN JOSE, CA 95129

Store #: 20170 55066-003 Project # Concept: MCS Palette: 4/10/14

Issue Date: Design Manager: LEED® AP:

Production Designer


Checked by: A. HUMAYDEN


INTERIOR ELEVATIONS

Sheet Number:

I-2102

As indicated

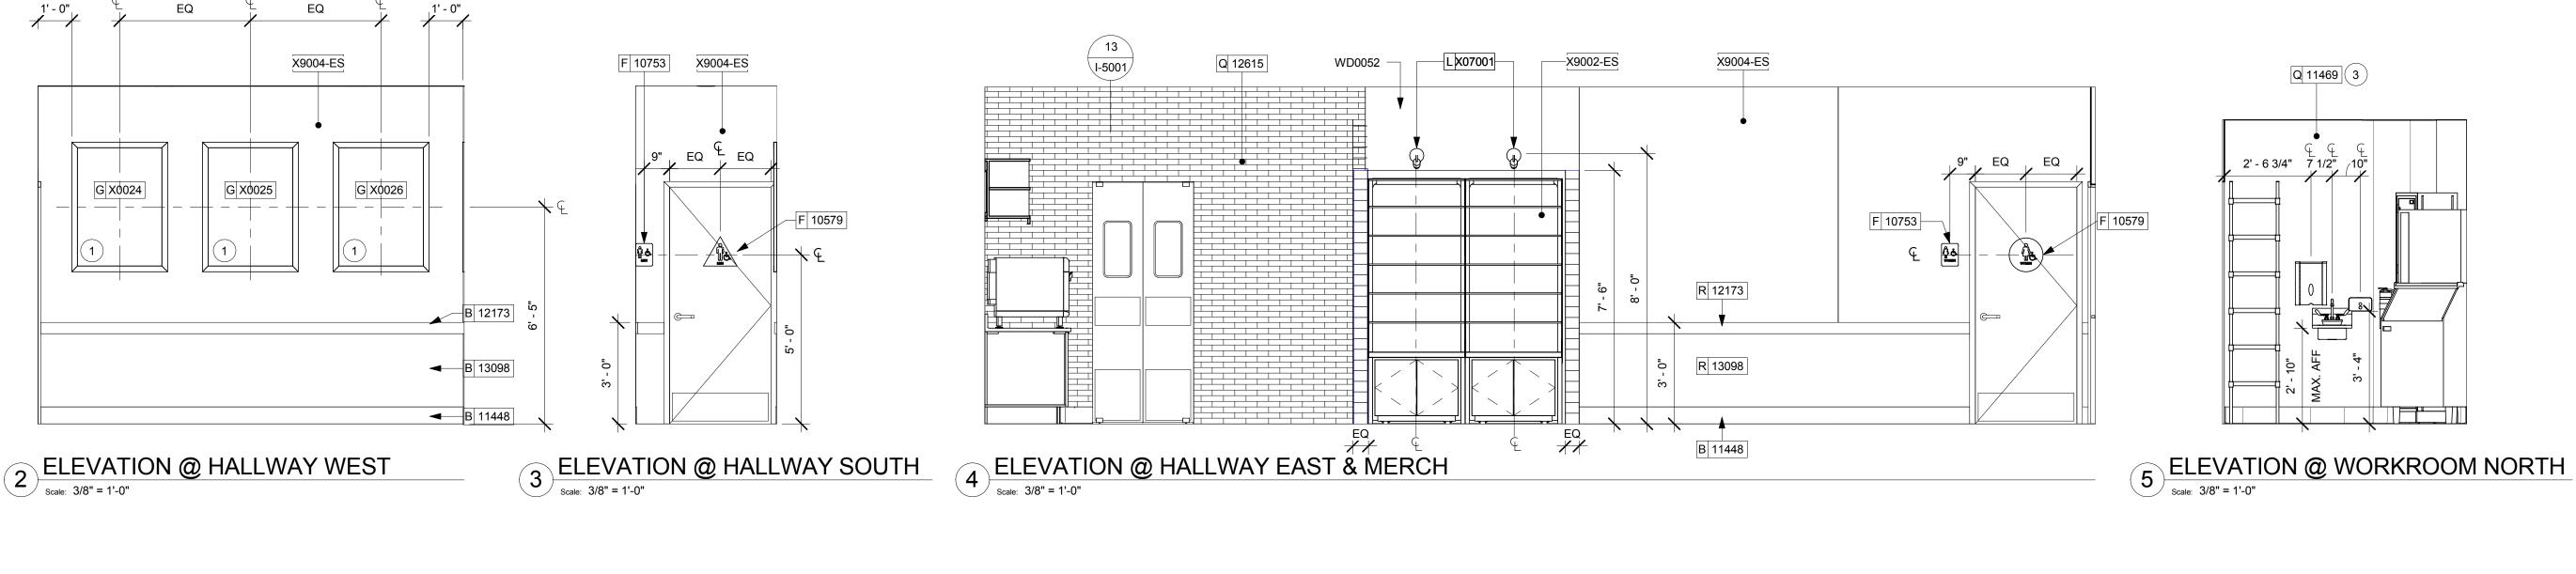

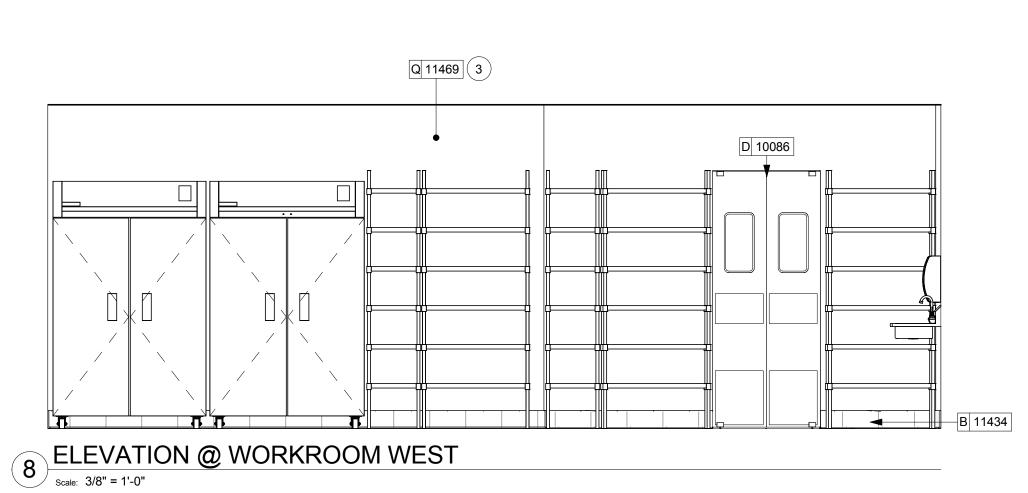

Q 11469 3

ELEVATION @ WORKROOM SINK

B 11434

(1) I-5013

ELEVATION @ WORKROOM SOUTH


Scale: 3/8" = 1'-0"

Q 11469 3

B 11434



Scale: 1/2" = 1'-0"

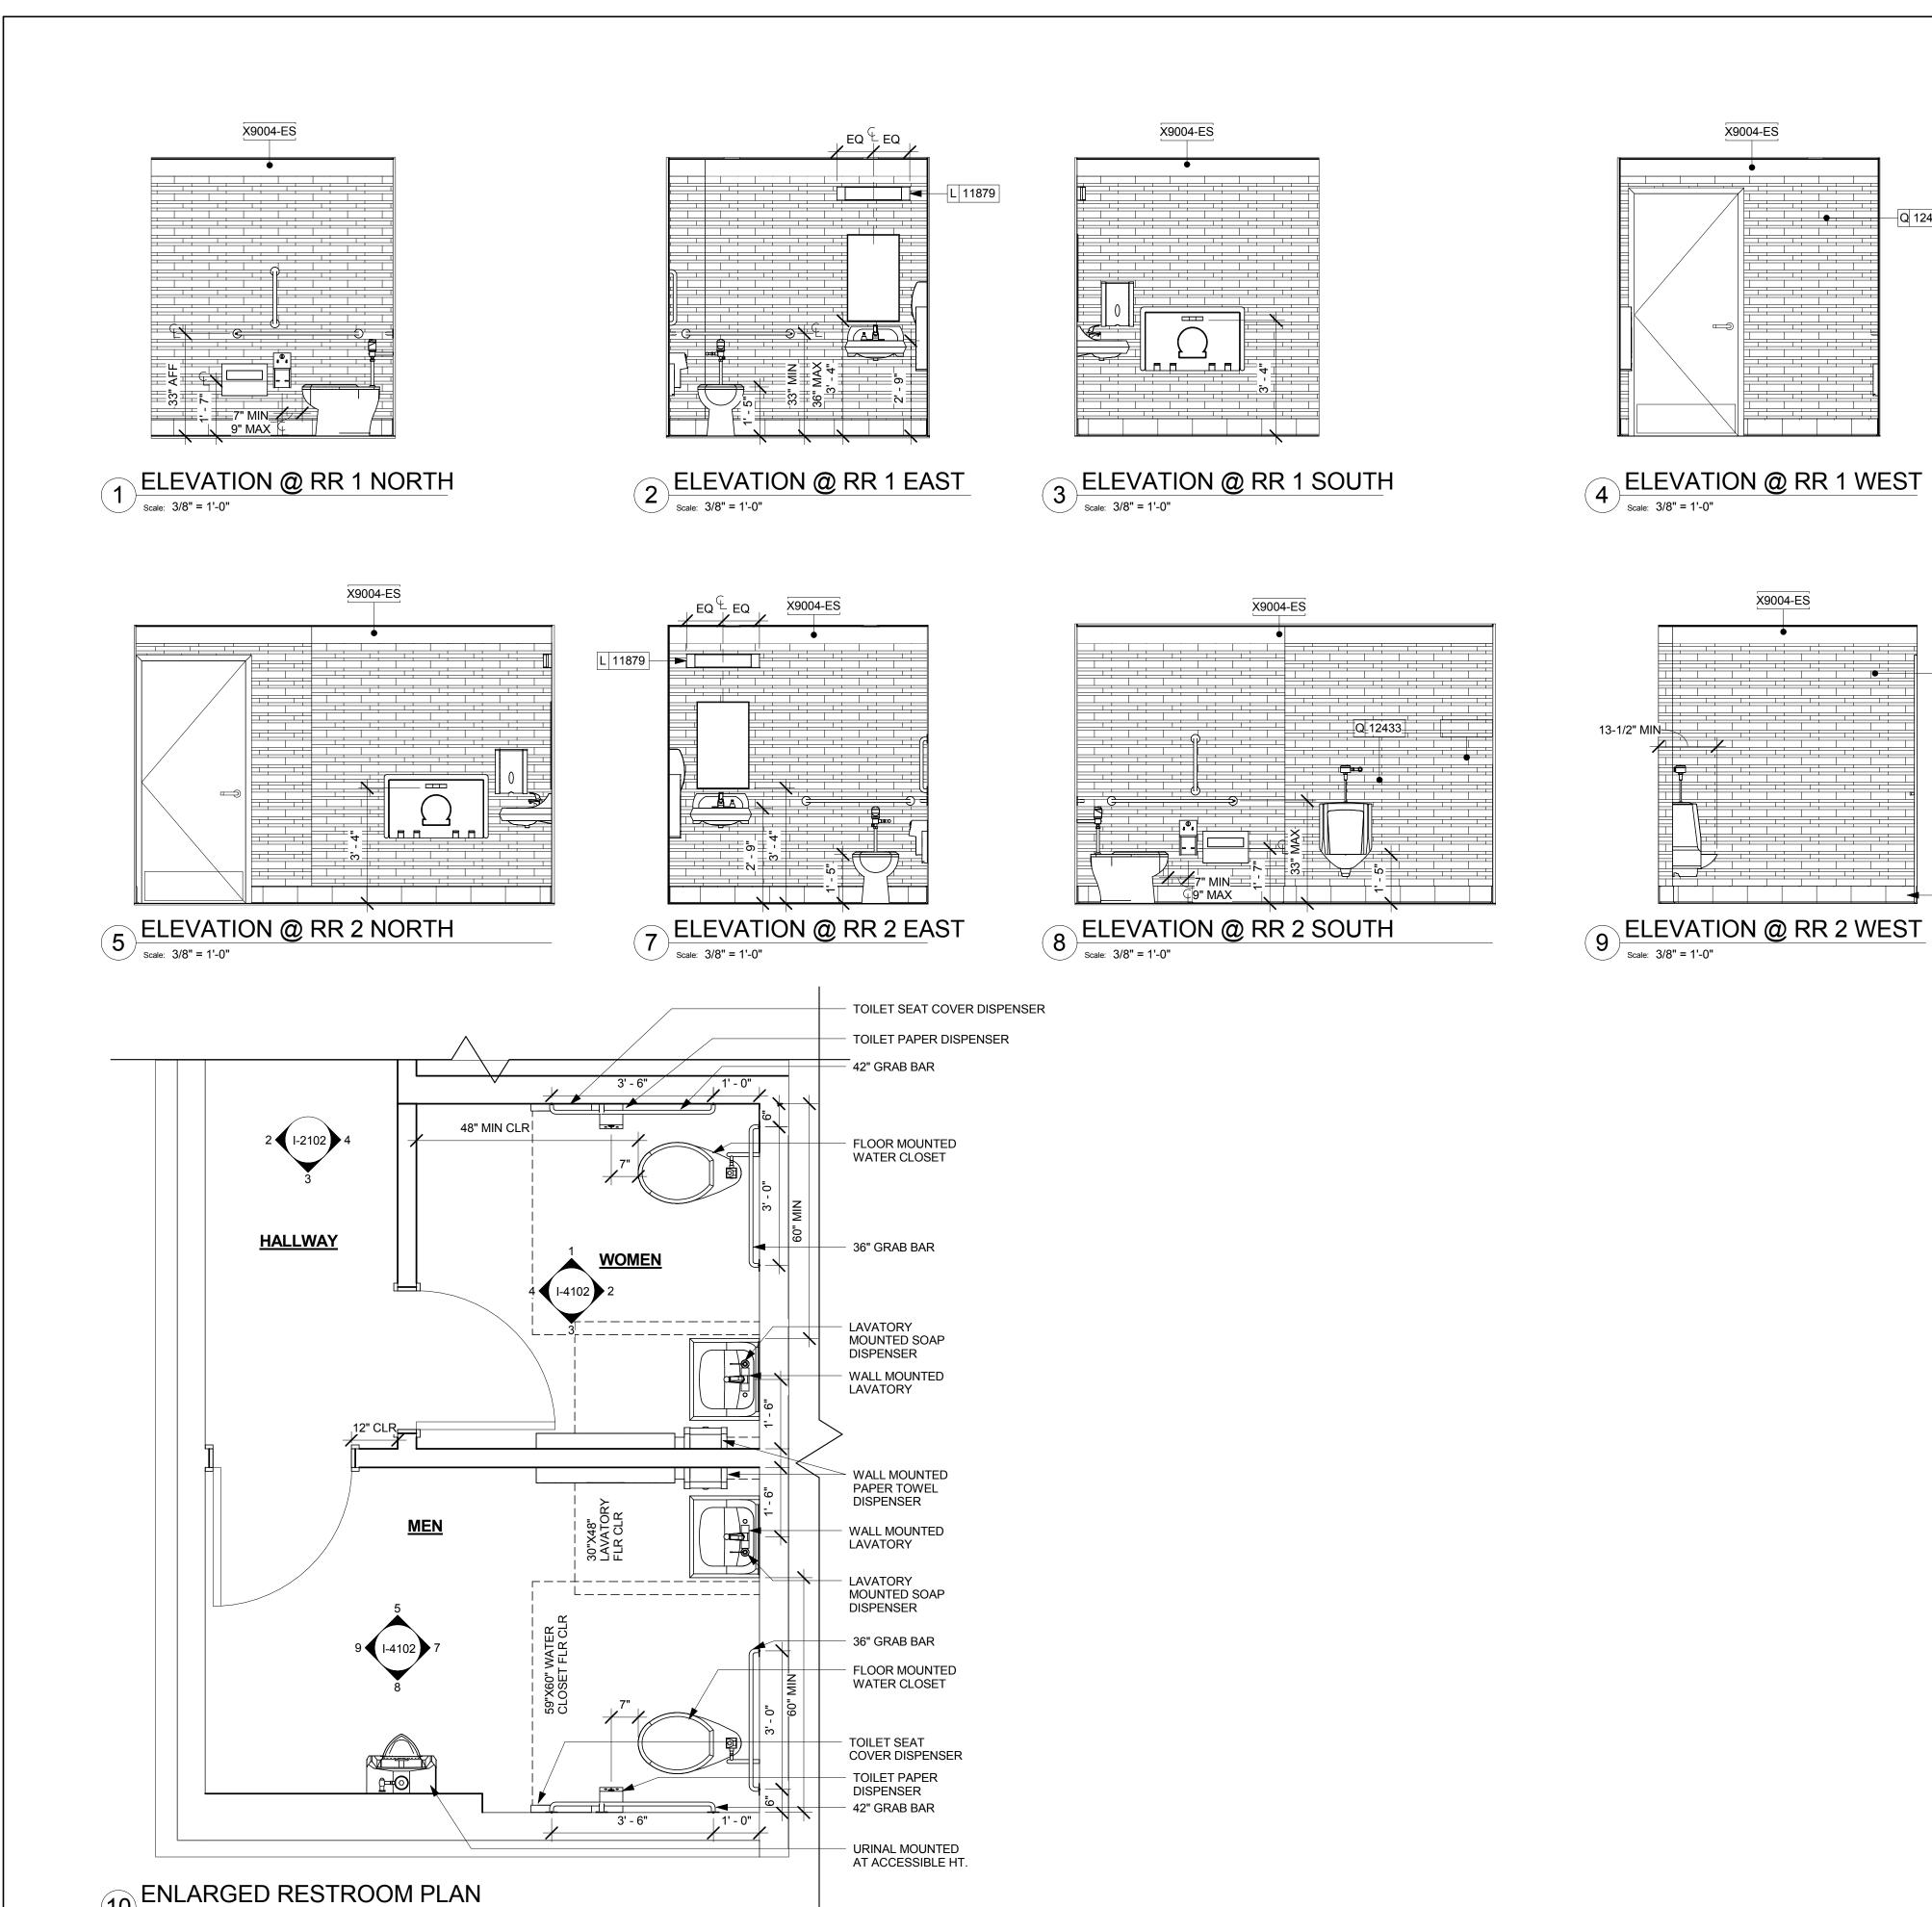

ENLARGED RESTROOM PLAN NOTES

A. DETAILS ARE FOR REFERENCE ONLY.

X9004-ES

X9004-ES

Q 12433

Q 12433

—B X9001

B. ALL RESTROOM ACCESSORIES MOUNTING HEIGHTS TO MEET ACCESSIBILITY REQUIREMENTS PER STARBUCKS ACCESSIBILITY

C. GENERAL CONTRACTOR TO VERIFY ALL DIMENSIONS AND NOTIFY STARBUCKS CONSTRUCTION MANAGER OF ANY DISCREPANCIES PRIOR TO CONSTRUCTION. ALL DIMENSIONS TO BE TAKEN FROM DESIGNATED DATUM POINT.

D. DIMENSIONS ARE TO FACE OF FINISHED SURFACE.

BABY CHANGING STATION NOTES

1. CHANGING STATION IS TO BE INSTALLED PER MANUFACTURER'S INSTRUCTIONS. UNIT IS TO BE FASTENED TO STRUCTURE AT ALL SIX CHASSIS ATTACHMENT POINTS. STANDARD INSTALLATION IS ATTACHMENT TO WOOD STUDS AND/OR WOOD BLOCKING. FOR NON-STANDARD FRAMING CONDITIONS OTHER THAN CONCRETE, USE TOGGLER SNAPTOGGLE HEAVY DUTY TOGGLE BOLTS TO SECURELY ATTACH CHASSIS TO WALL. FOR CONCRETE WALLS, USE FISCHER S-PLUG FIXINGS TO ANCHOR FASTENERS. SUBSTITUTION OF FASTENERS OTHER THAN THE MANUFACTURER AND PRODUCT SPECIFIED IS NOT ALLOWED WITHOUT PRIOR APPROVAL. LOAD TEST AFTER INSTALLATION WITH 100 LB. WEIGHT FOR 15 MINUTES.

2. LOCATE STATION TO ALLOW NECESSARY CLEARANCE FOR OPERATION OF ALL RESTROOM FIXTURES. LOCATION SHALL NOT IMPEDE ACCESS, EGRESS, OR DOOR SWING. VERIFY ANY ALTERNATE LOCATION OR INSTALLATION APPROACH WITH STARBUCKS PROJECT LEAD.



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		Revis	sion Schedule
Rev	Date	Ву	Description
			-

SARATOGA

Store #: 55066-003 Project #

Concept: Palette: Issue Date:

Design Manager:

LEED® AP: Production Designer:


ENLARGED RESTROOM PLAN AND ELEVATIONS

Sheet Number:

I-4102

A. HUMAYDEN



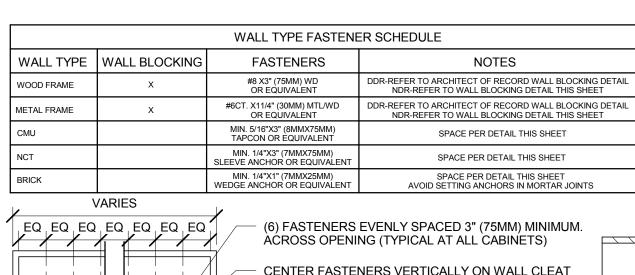

FASTENER SCHEDULE" FOR SPECIFICATION.


- ADJUSTABLE SHELF (IF APPLICABLE)

1/2 OFFSET (BRICK)

METAL TRIM TO BE PAINTED

STUD WALL BLOCKING REQUIREMENTS: WOOD STUD WALLS REQUIRE MIN. 2"X6" (50MMX150MM) WOOD BLOCKING SECURED FLUSH TO STUD FACE WITH (3) 10D NAILS (OR EQUIVALENT)

METAL STUD WALLS REQUIRE MIN. 2"X6" (50MMX150MM) WOOD BLOCKING SECURED FLUSH TO STUD FACE WITH MIN. (3) #6 CT. 1.25" (30MM) SCREWS (OR EQUIVALENT)

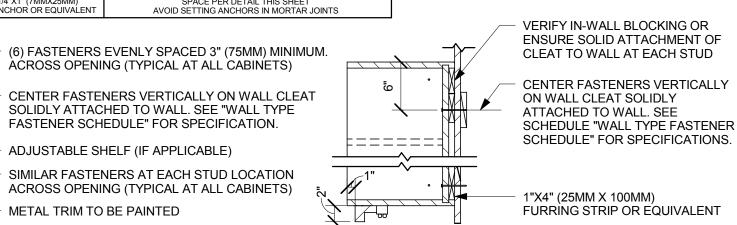

USE WINGNUTS AT BRACKET MOUNT TO ADJUST VERTICAL HEIGHT OF MENU AS NEEDED 6'-1" AFF - BOTTOM OF MENU MENU BOARDS ARE HINGED TO ALLOW ACCESS TO CABINET SHELVES BEHIND ATTACH PLASTIC MENU STOPS TO CABINET VERTICAL EDGES (SUPPLIED BY CASEWORK VENDOR) UNDERCABINET TASK LIGHT DOUBLE HEIGHT STORAGE

CABINET AT BACK BAR WALL

SCREW MENU HINGE TO TOP OF CABINET. ALIGN PIANO HINGE

JOINT TO CABINET EDGE

7'-10" - TOP OF CABINET


MENU BOARD CABINET BOTTOM PANEL FLEX CONDUIT TO TASK LIGHT **UNDERCABINET TASK** LIGHT TO BOTTOM **CORNER OF CABINET CONTINUOUS TASK** LIGHT VALANCE

CASEWORK MOUNTING - MENU BOARD Scale: 1/4" = 1'-0"

GYPSUM WALL BOARD

CEMENTITIOUS BOARD

Scale: 3" = 1'-0"

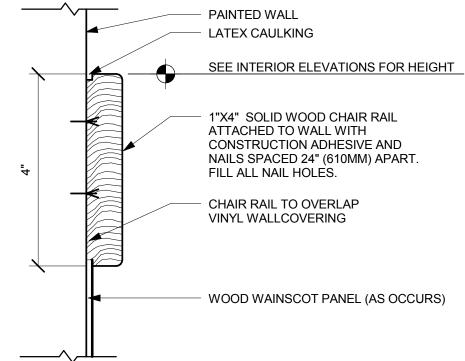




WOOD CHAIR RAIL 6 WALL TILE ABOVE SST BACKSPLASH

Scale: 3" = 1'-0"


GYPSUM WALL BOARD CEMENTITIOUS BOARD WALL TILE FLEXIBLE SEALANT SOLID SURFACE BACKSPLASH ALIGN OPEN AREA BEHIND SOLID SURFACE



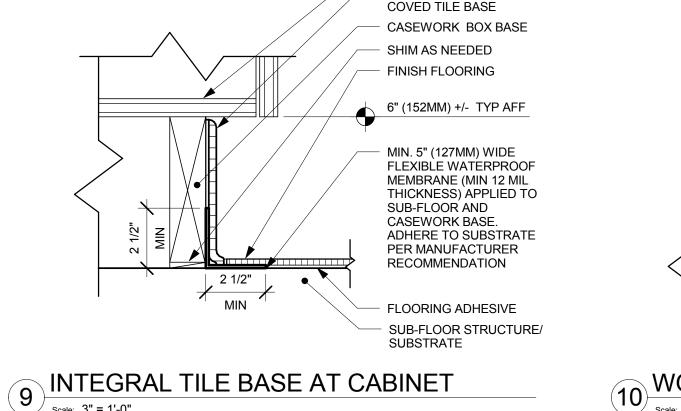

CASEWORK

BULLNOSE SANITARY

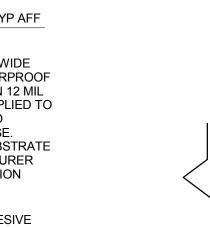

ALIGN


FIBERGLASS REINFORCED PLASTIC BASE DETERMINED BY MARKET WOOD BASE 6" (150MM) - FLOORING

WOOD BASE AT DIE WALL

Scale: 3" = 1'-0"

FINISH PANEL

WOOD BASE 6" EXISTING FLOORING

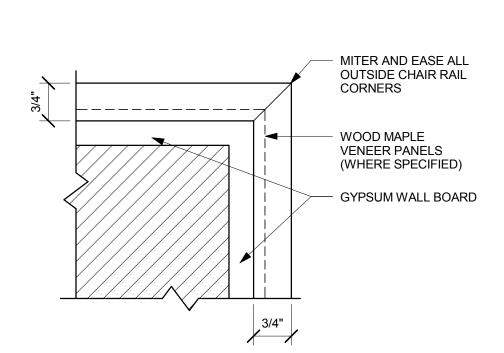

BACKBAR WALL TILE PATTERN - 1/2 OFFSET

| Scale: 1 1/2" = 1'-0"

CHAIR RAIL CORNER

STOREFRONT DOOR AND

SCHLUTER SYSTEMS 3/8" EDGE

METAL, SCHIENE-E100. SLIDE

NEW WALK OFF MAT -

METAL LEG UNDER MAT

WATERPROOF MEMBRANE,

(ONLY IF ON WOOD SUBFLOOR)

THRESHOLD

FLOOR TILE -

EXISTING OR NEW

Scale: 1" = 1'-0"

- - - - - -

=====≠


UPPER CABINET ATTACHMENT

SCHLUTER METAL TRIM AT WALL TILE PROFILE: JOLLY FINISH: ACGB (BRUSHED CHROME ANODIZED ALUMINUM) GROUT, TYP. BACKBAR WALL TILE, TYP. SUBSTRATE, TYP.


2 1/2"


TRANSITION - TILE TO WALK OFF MAT

| Scale: 3" = 1'-0"

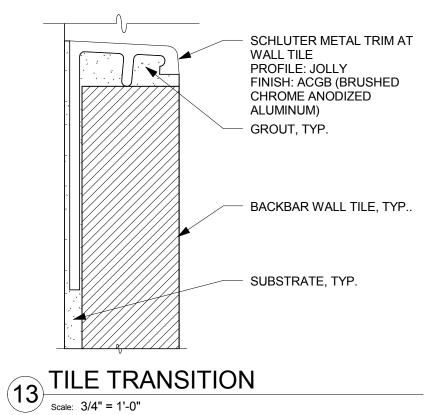

TASK LIGHT UNDER CABINET

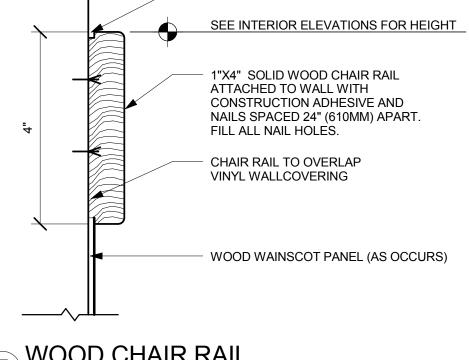

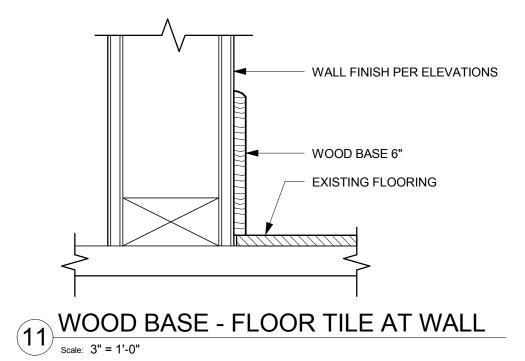

DESIGN DETAILS

Starbucks Coffee

Company

2401 Utah Avenue South

Seattle, Washington 98134

(206) 318-1575

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Architect of Record

Revision Schedule

Description

COUNTY:

20170

MCS

4/10/14

ANDREW

HUMAYDAN

A. HUMAYDEN

As indicated

55066-003

SALASO'BRIEN

305 South 11th Street

San Jose, CA 95112-2218

p. 408.282.1500 | f. 408.297.2995

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Scale:

SARATOG

Store #:

| Project #

Concept:

Palette:

Issue Date:

Design Manager:

Production Designer:

LEED® AP:

Checked by:

Project Name:
KIELY &
Project Address:
403 SARAT(SAN JOSE,


Sheet Number:





Scale: 1 1/2" = 1'-0"

Scale: 1 1/2" = 1'-0"

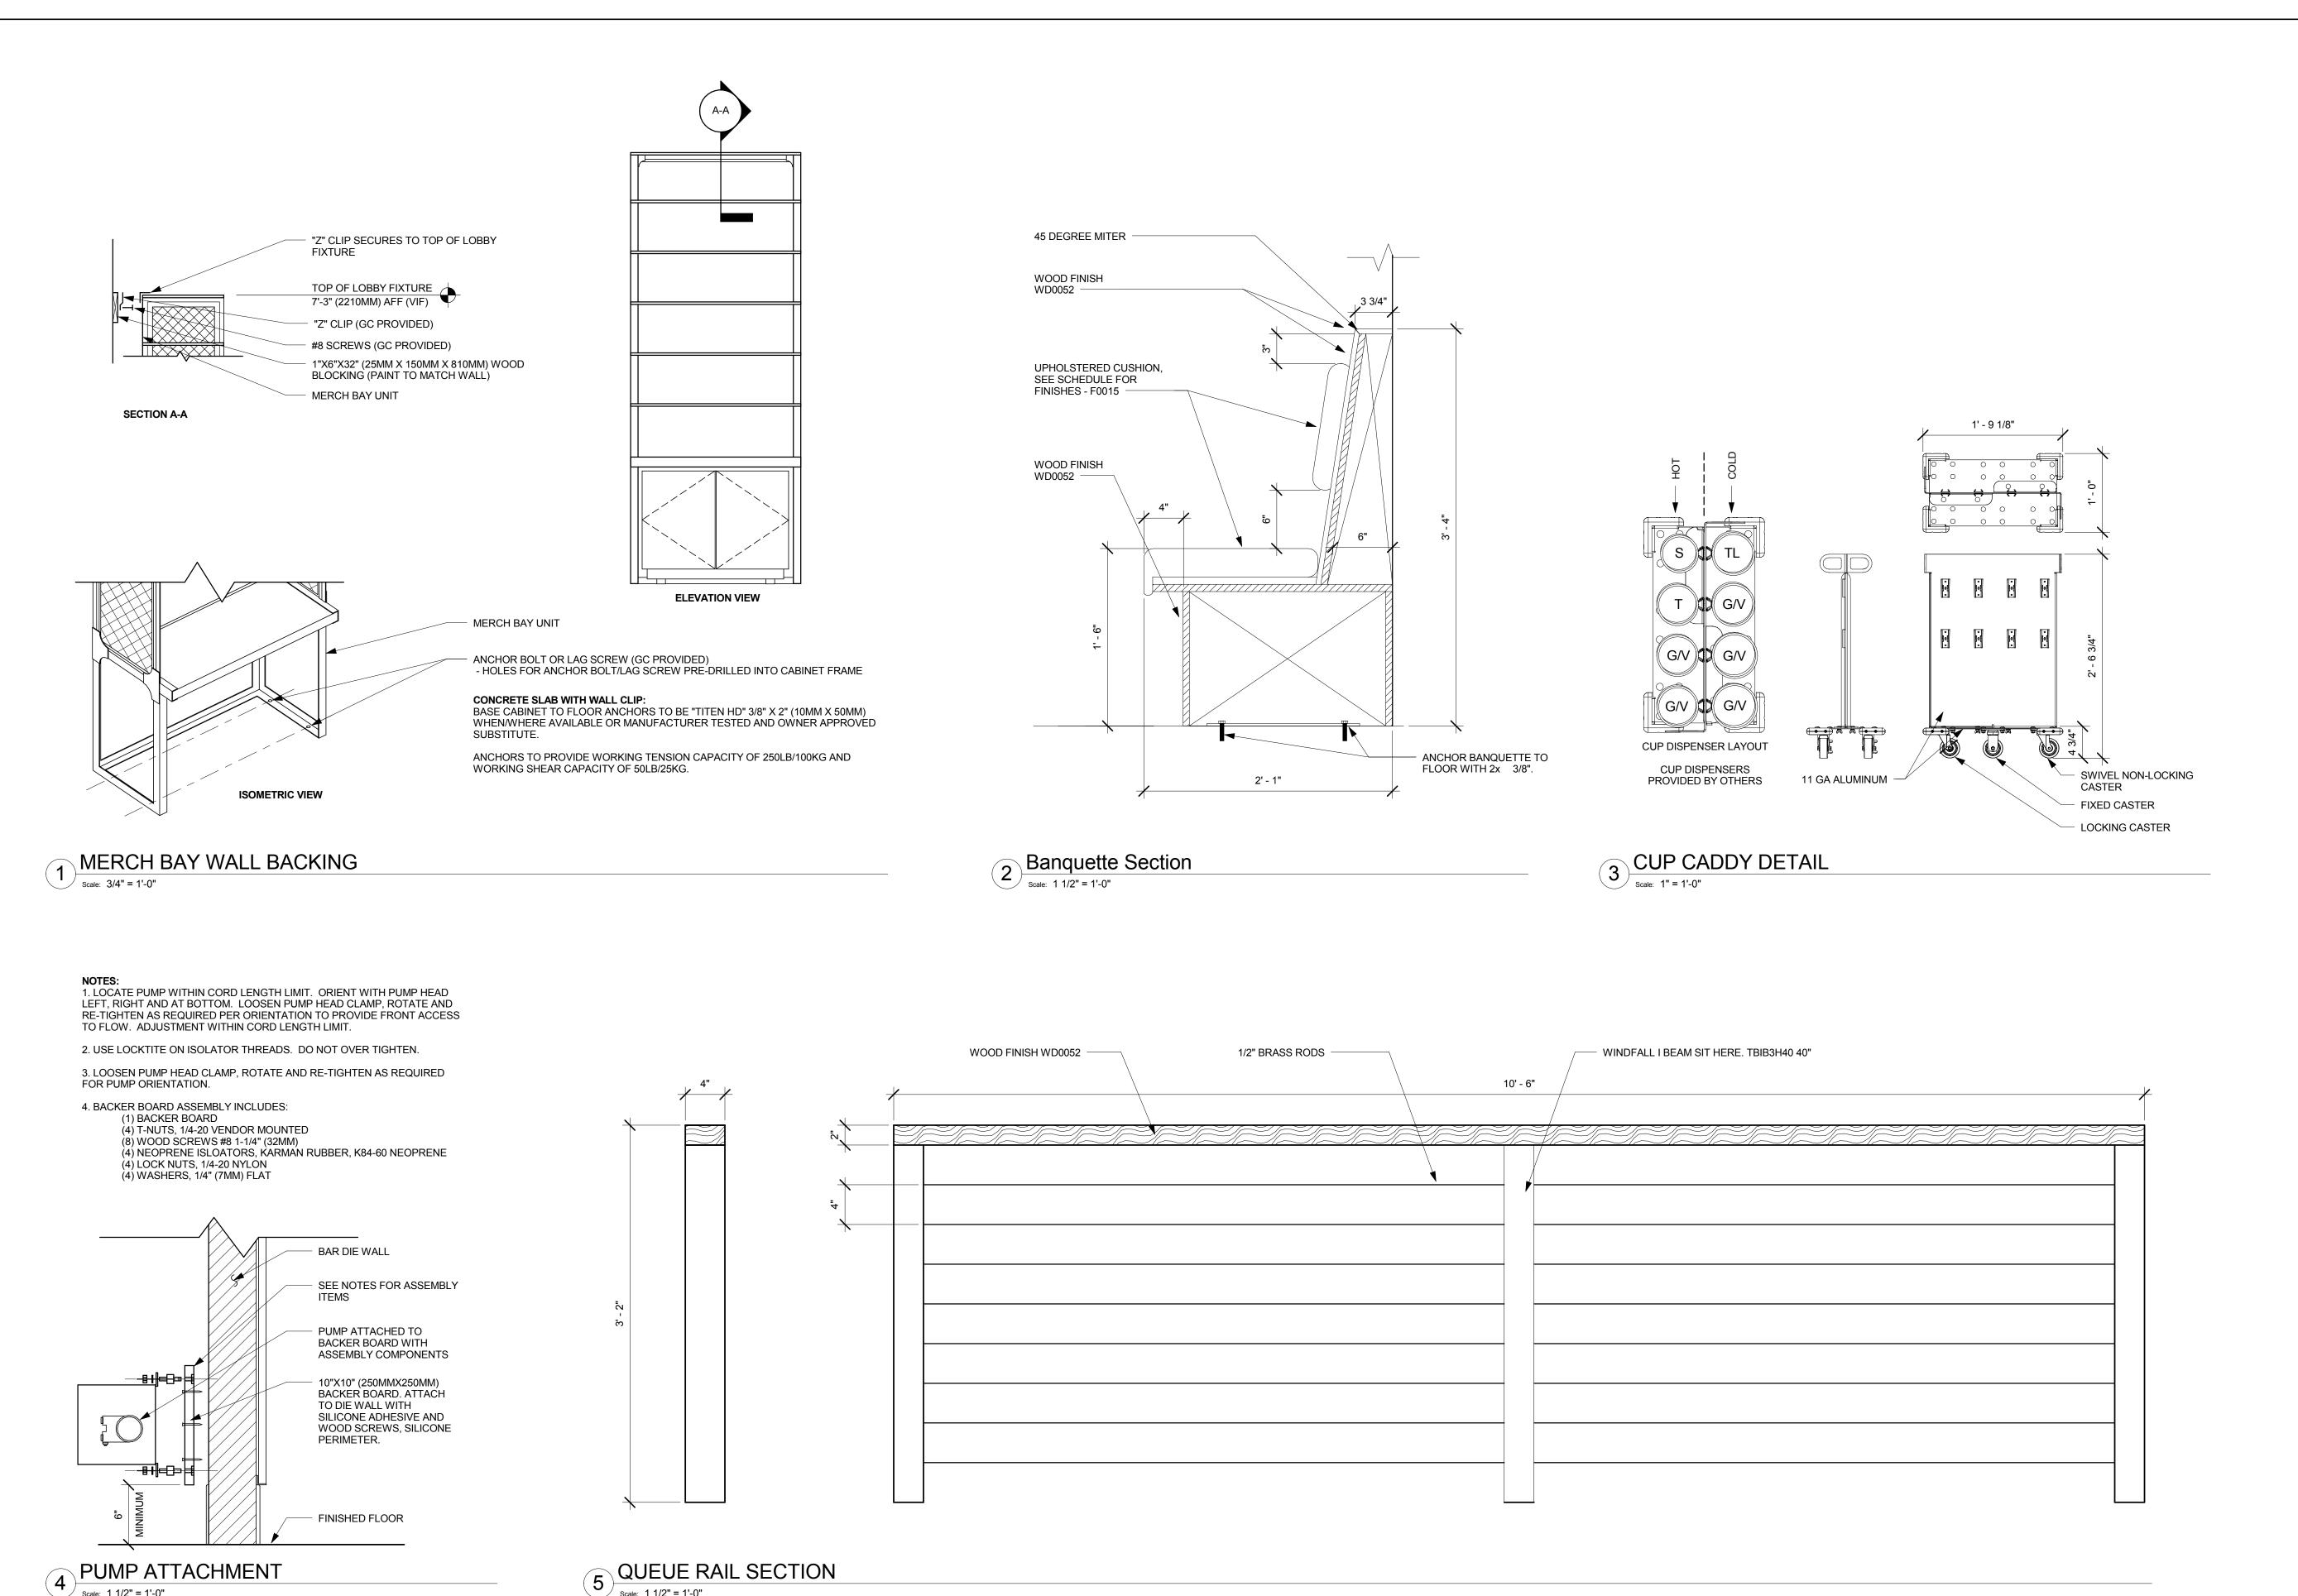

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Revision Schedule Description

COUNTY:

20170 Store #: | Project #: 55066-003 MCS Concept:

4/10/14

A. HUMAYDEN

As indicated

Palette: Issue Date: Design Manager:

ANDREW HUMAYDAN LEED® AP:

Production Designer: Checked by:

Sheet Title:

DESIGN DETAILS

Sheet Number:

VERTICAL HANGERS:

SUSPENSION WIRES SHALL BE OF 12 GA. SPACED @ 4 FEET O.C. MAXIMUM ALONG EACH MAIN BEAM. SUSPENSION WIRES SPACED AT UP TO 5 FEET O.C. SHALL BE OF 10

EACH VERTICAL WIRE SHALL BE ATTACHED TO THE CEILING SUSPENSION MEMBER WITH A MINIMUM OF THREE TURNS AND TO THE STRUCTURE ABOVE WITH A CONNECTION CAPABLE OF CARRYING NOT LESS THAN 100 POUND ALLOWABLE LOAD.

PERIMETER HANGERS:

AT ALL LOCATIONS THE TERMINAL ENDS OF EACH MAIN BEAM OR CROSS TEE SHALL BE SUPPORTED INDEPENDENTLY A MAXIMUM OF 8" FROM EACH WALL WITH 12 GAUGE WIRE. PERIMETER WIRES MUST BE PLUMB WITHIN 1 IN 6 UNLESS COUNTER SLOPING WIRES ARE PROVIDED.

LATERAL FORCE BRACING:

HORIZONTAL RESTRAINT SHALL BE PROVIDED BY FOUR 12 GAUGE WIRES SECURED TO THE MAIN BEAM WITHIN 2" OF THE CROSS TEE INTERSECTION AND SPLAYED 90° FROM EACH OTHER AT AN ANGLE NOT EXCEEDING 45° FROM THE PLANE OF THE CEILING. THESE HORIZONTAL RESTRAINT POINTS SHALL BE PLACED 12 FEET OC MAXIMUM IN BOTH DIRECTIONS WITH THE FIRST POINT WITHIN 4 FEET FROM EACH WALL. ATTACHMENT OF THE RESTRAINT WIRES TO THE STRUCTURE ABOVE SHALL BE ADEQUATE FOR THE LOAD IMPOSED.

SUSPENSION GRID SYSTEM TO BE COMPATIBLE WITH SUSPENDED TILE SPECIFIED. SEE REFLECTED CEILING PLAN FOR SPECIFICATIONS.

CROSS TEE 12 GA. SPLAY WIRE BRACING IN PLANE OF EACH BEAM. VERTICAL THREE TIGHT TURNS ANGLE = 45 DEGREES

VERT. BRACING @ EACH

LATERAL BRACING

MAIN BEAM. ALL MAIN

BEAMS ARE TO BE

HEAVY DUTY (HD).

TYPICAL CEILING BRACING

MINIMUM 3/4" AT

ATTACHED WALLS

PERIMETER BEAMS/TEES AT NON-FIXED END

LOCATION.

SPREADER BAR OR OTHER SUITABLE SYSTEM REQUIRED TO KEEP PERIMETER COMPONENTS FROM SPREADING APART 8" MAX.

ATTACH AT TWO ADJACENT WALLS WITH POP RIVETS OR APPROVED METHOD

PERIMETER BEAMS/TEES AT FIXED END

WIRE TIE CONNECTIONS

HANGER WIRE, TYP. **NEW SUSPENDED** CEILING GRID AND ACOUSTIC TILE 45 DEG. ANGLE BRACE 5/8" TYPE 'X' GWB


GWB SOFFIT LIGHTING FIXTURE TRACK

ATTACHED TO GWB CEILING FRAMING w/ #12x1 1/2" PANHEAD SH. MTL. SCREWS AT 2'-0" O.C.

CEILING FRAMING, PROVIDE

BLOCKING AS NEEDED

SURFACE MOUNTED TRACK - GWB

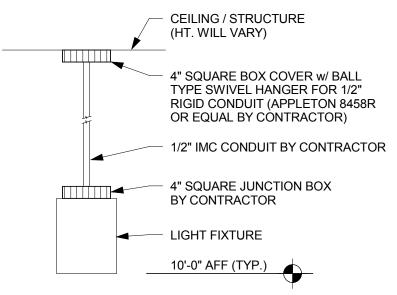


NOTE: CONTRACTOR SHALL PROVIDE SUITABLE MEANDS OF CONNECTION TO SUPPORT CONTINUOUS LOAD OF 50 LBS

PENDANT MOUNTED DOWNLIGHT Scale: 1 1/2" = 1'-0"


PROVIDE HANGERS AND SEISMIC **BRACING PER** DETAIL 1/I-5003 10' - 0" 90 DEG. ANGLE BY GRID MFR. **CONTINUOUS ANGLE**


CEILING DETAIL

Scale: 1" = 1'-0"

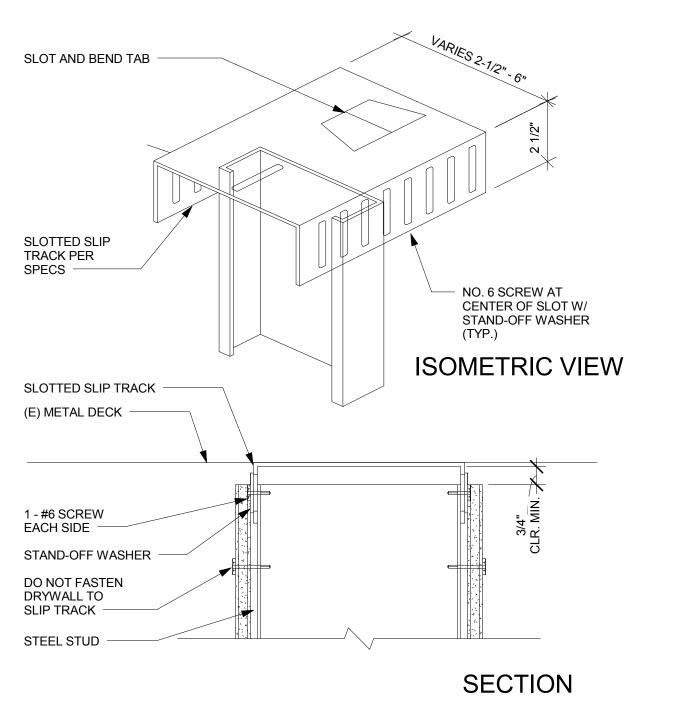


SLIP TRACK DETAIL - TYP. WALL

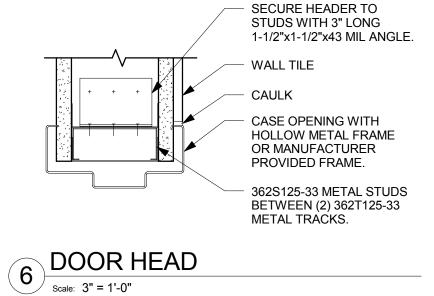


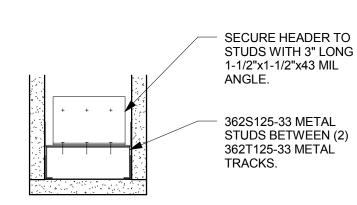

DOOR HEAD - CASED

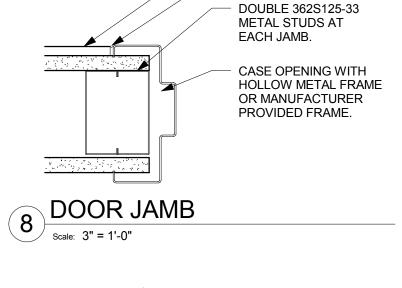

SOFFIT DETAIL 1

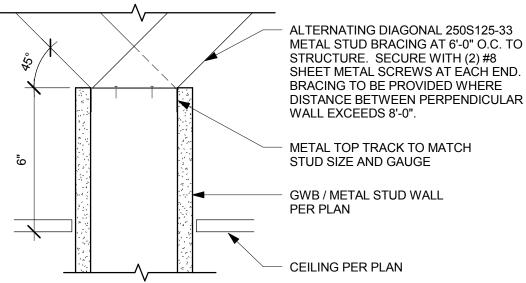

WALL TILE

CAULK

9 TOP OF WALL - BRACED



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Seattle, Washington 98134 (206) 318-1575

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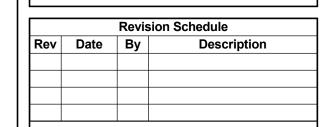
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Architect of Record

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Store #: 55066-003 Project # MCS

4/10/14

ANDREW

As indicated

Concept: Palette: Issue Date: Design Manager:

LEED® AP:

Production Designer: Checked by:

A. HUMAYDEN


DESIGN DETAILS


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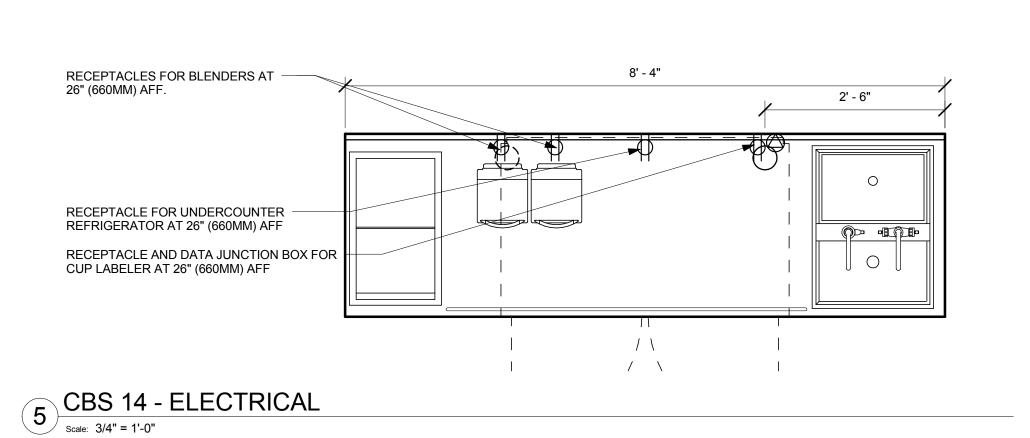



BREW 09 - ELECTRICAL

3 Scale: 3/4" = 1'-0"



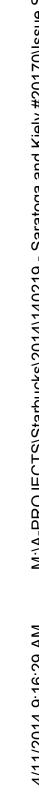

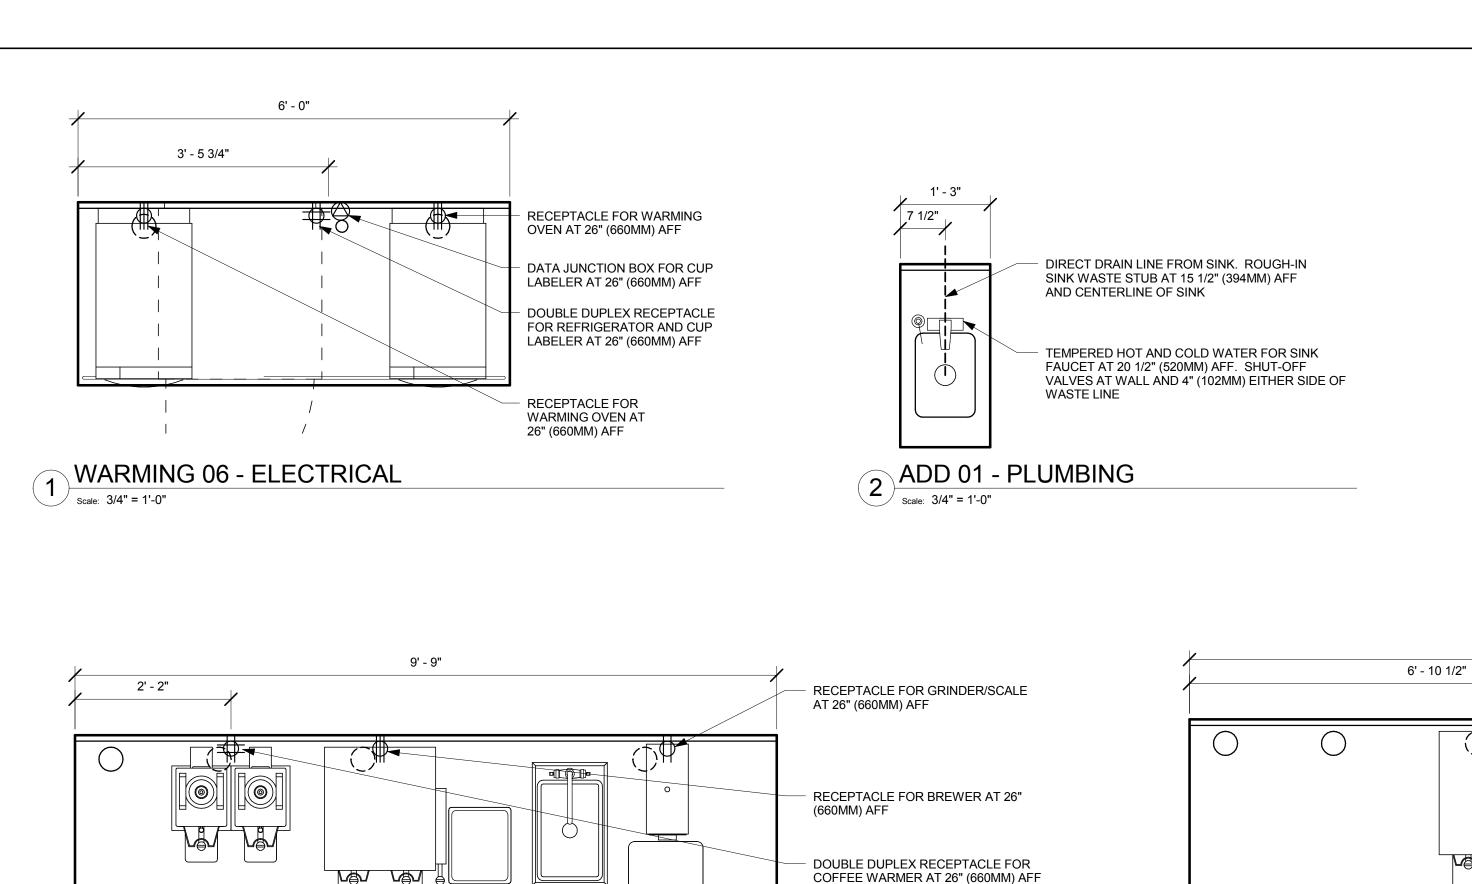

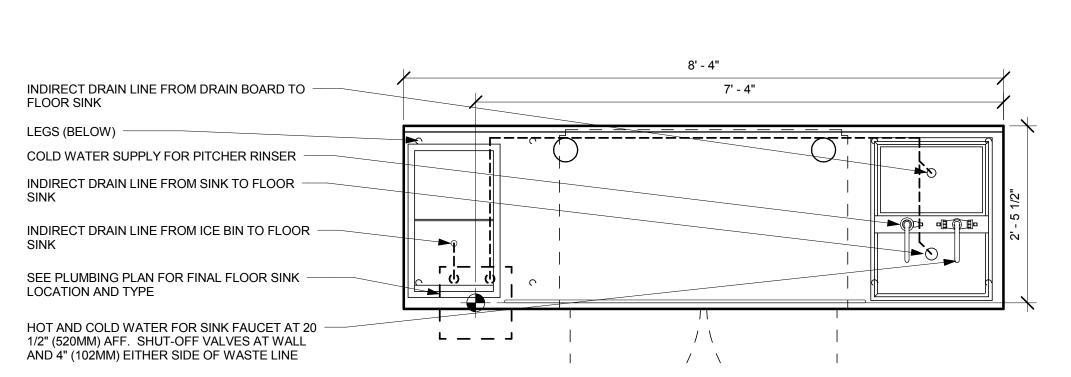

FILTERED COLD WATER SUPPLY

FOR BREWER WITH SHUT-OFF IN CABINET AT 24" (610MM) AFF

DIRECT DRAIN LINE FROM SINK.
ROUGH-IN SINK WASTE STUB AT 15

1/2" (394MM) AFF AND CENTERLINE

HOT AND COLD WATER FOR SINK FAUCET AT 20 1/2" (520MM) AFF.

SHUT-OFF VALVES AT WALL AND

4" (102MM) EITHER SIDE OF

OF SINK

WÀSTE LIŃE

9' - 9"

6 CBS 14 - PLUMBING

| Scale: 3/4" = 1'-0"

BREW 09 - PLUMBING



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Architect of Record SALASO'BRIEN 305 South 11th Street

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Revision Schedule

Rev Date By Description

SARATOGA

DGA AVE

CA 95129

ANTA CLARA COUNTY

Project Name:
KIELY & S
Project Address:
403 SARATO
SAN JOSE, C

Store #: 20170
Project #: 55066-003
Concept: MCS

Concept:
Palette:
Issue Date:
Design Manager:

4/10/14 er: ANDREW HUMAYDAN

LEED® AP:
Production Designer:

Checked by: A. HUMAYDEN


CASEWORK DETAILS


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Sheet Number:

I-5010

3/4" = 1'-0"




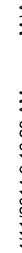

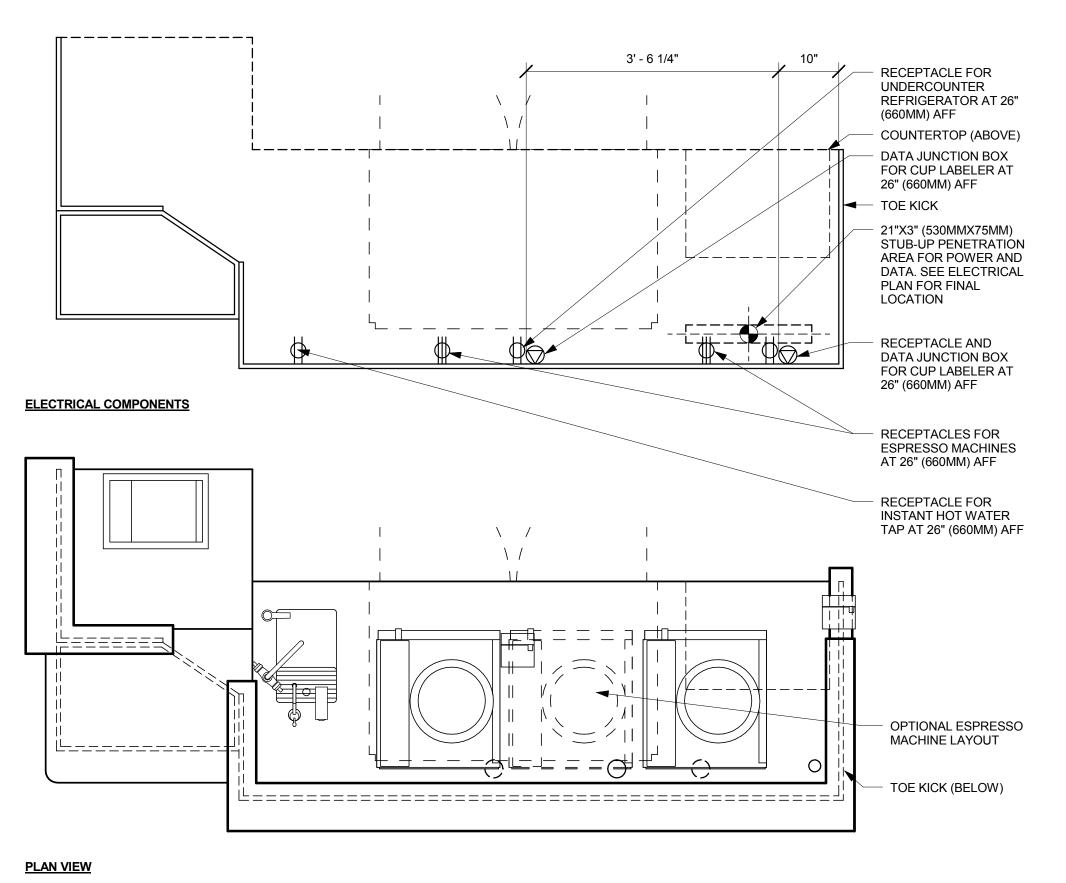
ESPRESSO 21 - ELECTRICAL

Scale: 3/4" = 1'-0"

3' - 2" DATA JUNCTION BOX AT 18" (460MM) AFF 18"X3" (460MMX75MM) STUB-UP PENETRATION AREA. SUPPLY POWER, DATA, AND PHONE CONDUITS FOR POS, AND POWER CONDUIT FOR PASTRY CASE. SEE ELECTRICAL DESIGN PLAN FOR FINAL LOCATION DOUBLE DUPLEX RECEPTACLE AT 18" (460MM) AFF JUNTION BOX FOR PHONE AT 18" (460MM) AFF DEDICATED POS DUPLEX RECEPTACLE AT 18" (460MM) AFF L______ BOX BASE ELECTRICAL COMPONENTS RECEPTACLE AND JUNCTION BOX FOR SAFE SECURITY AT 18" (460MM) AFF COUNTERTOP (ABOVE) BOX BASE (BELOW) F======= **PLAN VIEW** POS 13 - ELECTRICAL

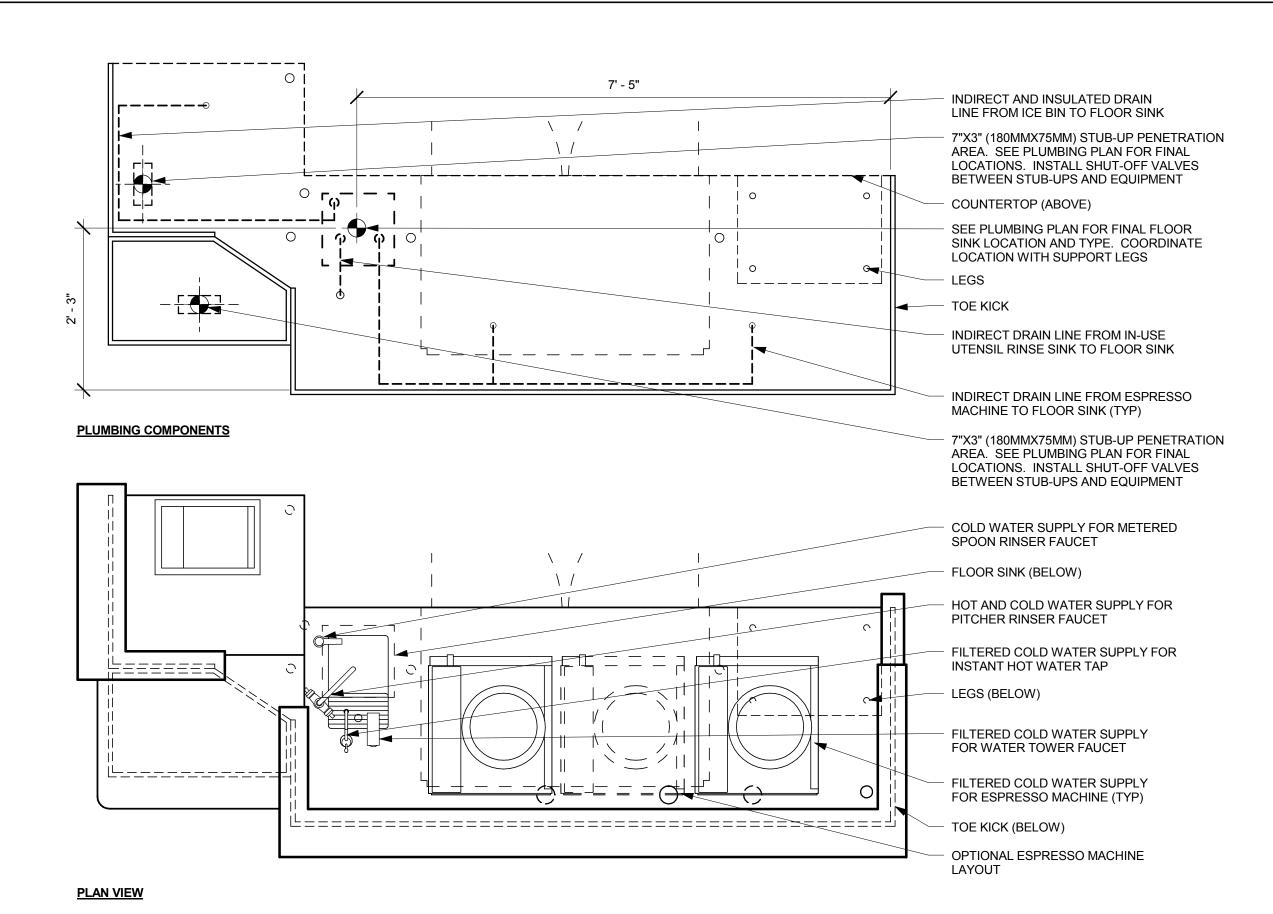

ESPRESSO 21 - PLUMBING

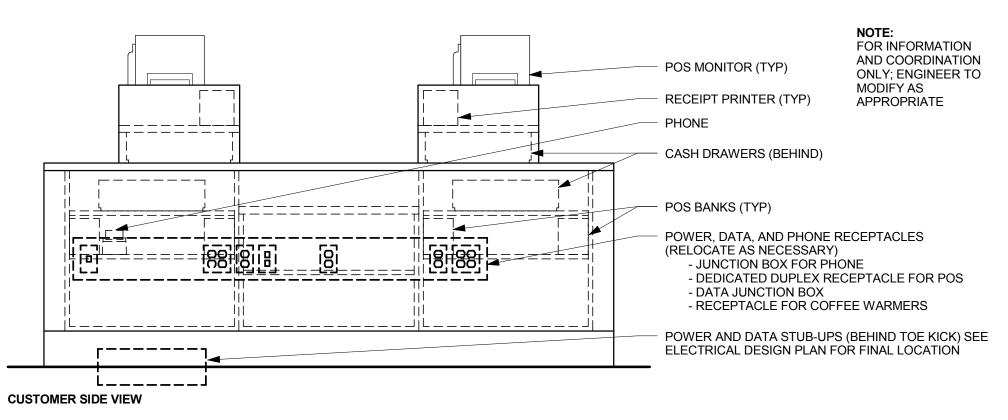

GENERIC DOUBLE POS MEP DIAGRAM

| Scale: 3/4" = 1'-0"



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Store #: 55066-003 Project # MCS Concept:

4/10/14

ANDREW

3/4" = 1'-0"

Palette: Issue Date: Design Manager:


LEED® AP:


Production Designer:

A. HUMAYDEN Checked by:


CASEWORK DETAILS


Sheet Number:

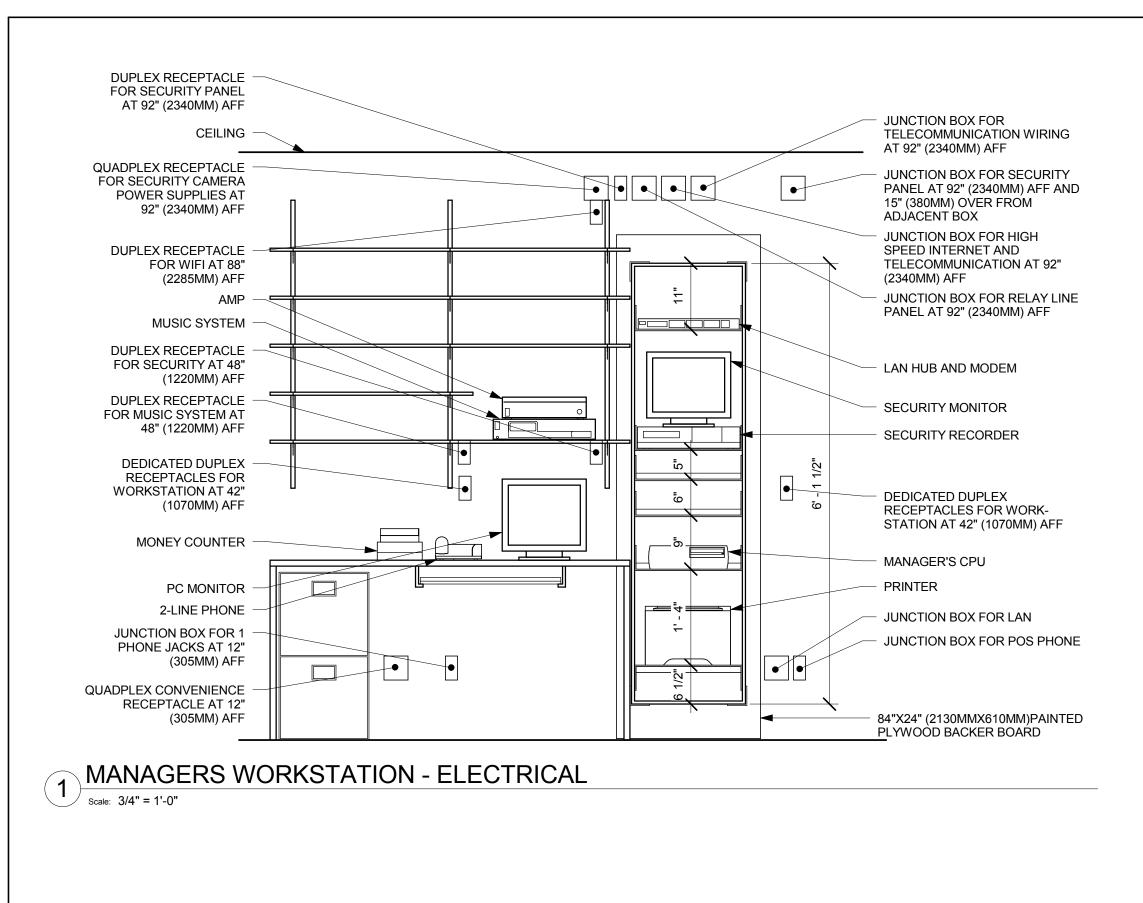


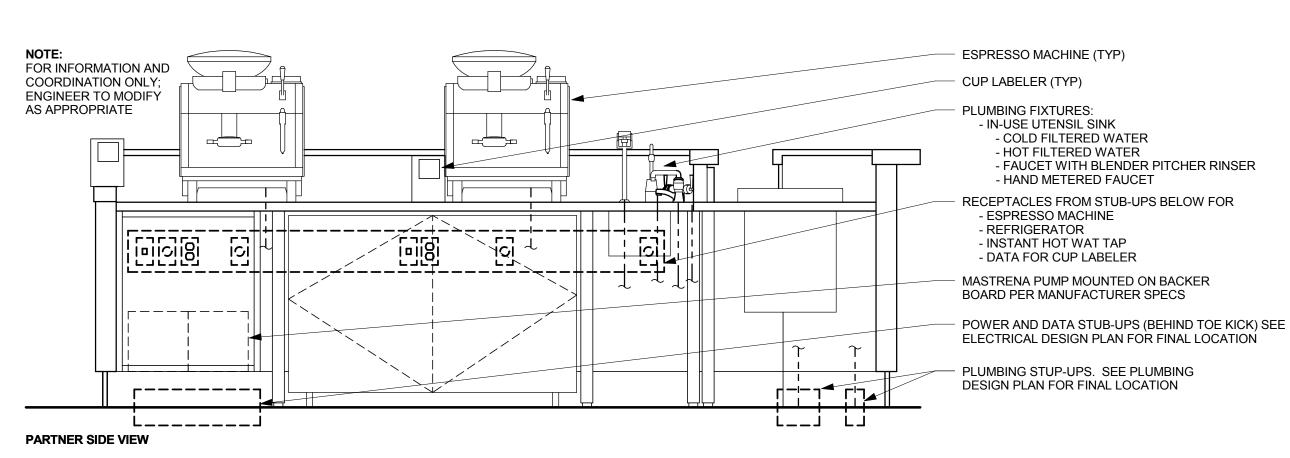


GENERIC DOUBLE ESP MEP DIAGRAM

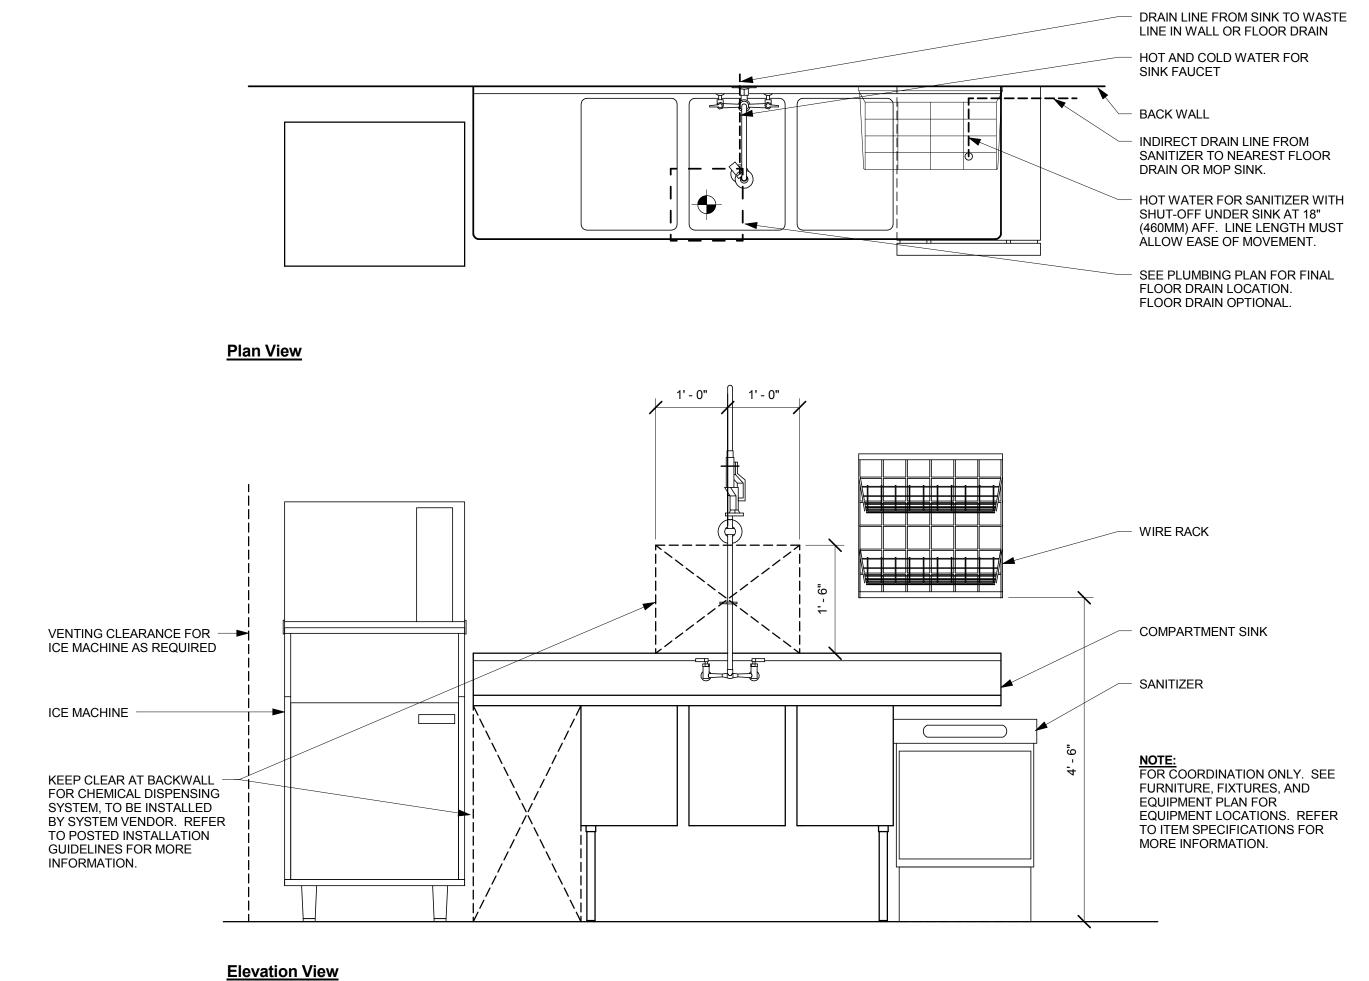


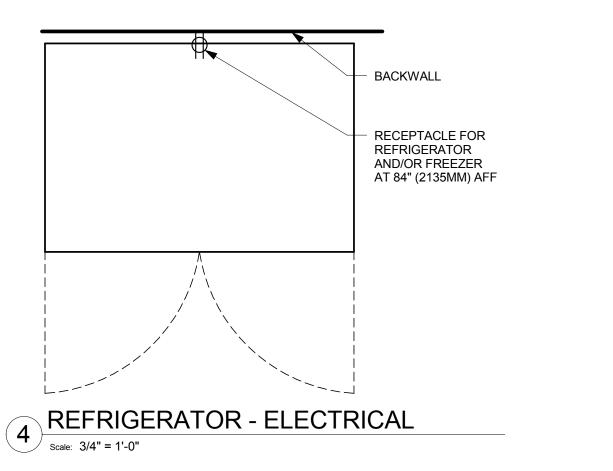

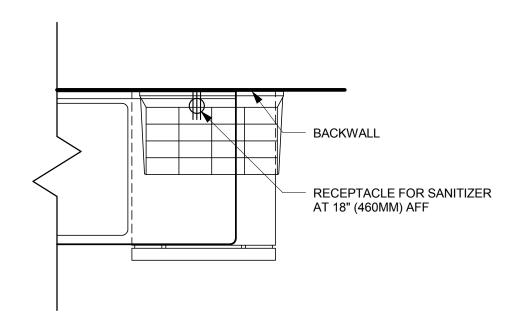

SANITIZING WORKSTATION - ELECTRICAL

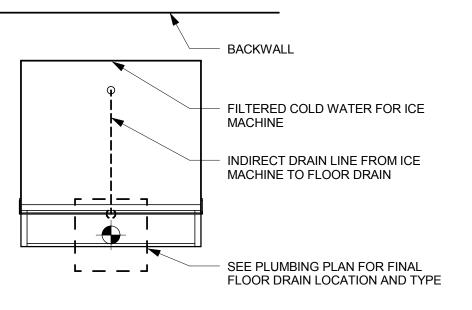

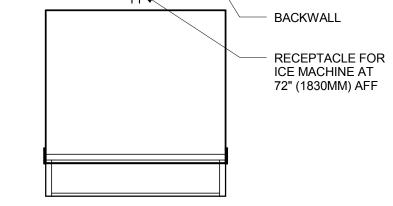

7 ICE MACHINE - ELECTRICAL



Starbucks Coffee Company 2401 Utah Avenue South

Seattle, Washington 98134

(206) 318-1575

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> parties. Architect of Record

nor liability to the other (except as stated above) until a written agreement is fully executed by both



SALASOBRIEN 305 South 11th Street San Jose, CA 95112-2218 o. 408.282.1500 | f. 408.297.2995 www.salasobrien.com

Revision Schedule Description

SARATOG

Store #: 55066-003 Project # MCS Concept: Palette: 4/10/14 Issue Date: Design Manager: ANDREW HUMAYDAN LEED® AP: Production Designer A. HUMAYDEN Checked by:

CASEWORK DETAILS

Sheet Number:


I-5012

3/4" = 1'-0"

3 SANITIZING (GENERIC) - PLUMBING

Scale: 3/4" = 1'-0"

6 ICE MACHINE - PLUMBING
Scale: 3/4" = 1'-0"

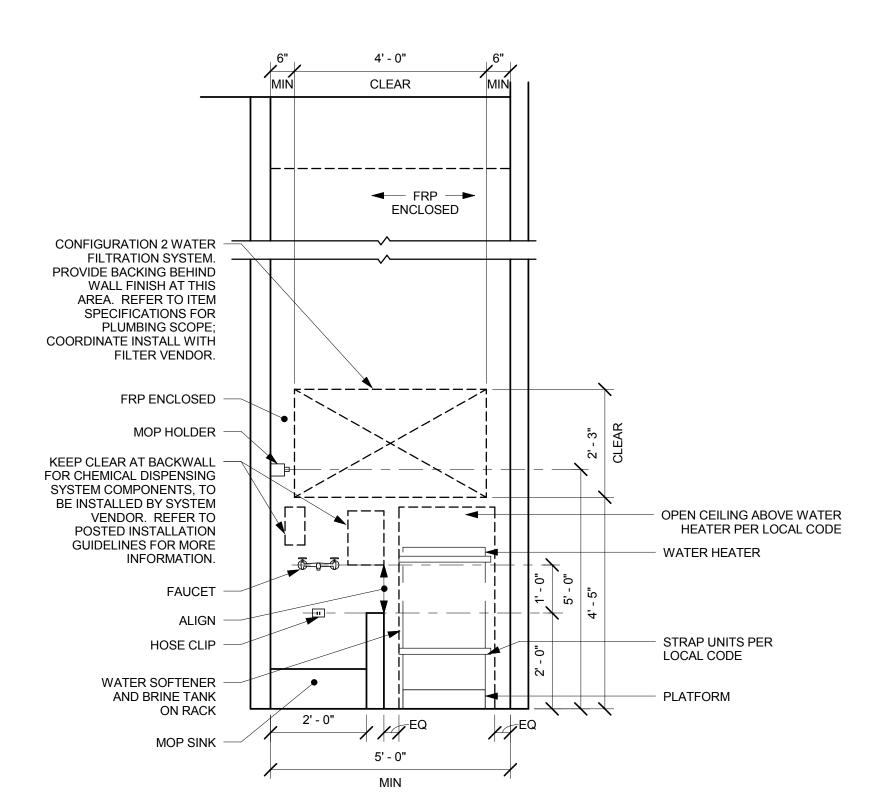

1 FILTRATION - GENERIC CONFIGURATION 2

| Scale: 1/2" = 1'-0"



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Architect of Record



Rev Date By	Description
	Description

Project #: 55066-003

Concept: Design Manager:

LEED® AP:

Store #:

A. HUMAYDEN

CASEWORK DETAILS

1/2" = 1'-0"

Sheet Number:

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	DATA DEVICE SCHEDULE - "A"					
DESIGN ID	COUNT	DESCRIPTION	RESP.	COMMENTS		
AUDIO VISU	AL		<u>'</u>			
10005	1	MUSIC SYSTEM	VD	PLAY NETWORK		
10076	1	AMPLIFIER - 14IN 355MM	VD	PLAY NETWORK		
DATA			<u>.</u>			
10000	2	PHONE 1 LINE	SB	SMALLWARES		
10002	1	COMPUTER MANAGER WORKSTATION	VD	ZONES		
10007	1	PRINTER MANAGER WORKSTATION	VD	ZONES		
10011	1	EQUIPMENT RACK - 6FT 183CM	VD	ZONES		
10019	1	WIDE AREA NETWORK HARDWARE	VD	ZONES		
POINT OF S	ALE					
10003	2	REGISTER FULL SIZE	VD			
10014	2	POS PRINTER	VD			
10022	1	MONEY COUNTER	SB			
10029	4	POS BANK	SB			
SECURITY			·			
10004	1	ALARM SYSTEM	VD	SHORT CIRCUIT		
10024	1	SAFE LH - 20X18X26IN 510X455X660MM	VD	AMERICAN SECURITIES		
10028	1	SAFE BASE	SB			

CASEWORK SCHEDULE - "C"

RESP.

COMMENTS

DESCRIPTION

DESIGN ID COUNT

DESIGN ID	COUNT	DESCRIPTION	RESP.	COMMENTS
X0005	1	ADA queue rail bar 12' x 3" x 1'-7"	VD	WD0052
x0005	<u>'</u> 1	POS Cladding	VD	WD0032
CABINET	•	. CC Cladaling	1,12	
11902	1	CABINET - UPPER CUBBY - 28X16X15IN 700X405X375MM	VD	
11945	2	CABINET - 12IN 305MM	VD	
11972	1	CABINET - ESPRESSO - 24IN 610MM	VD	
11977	14	CABINET - UPPER CUBBY - 24X16X21IN 610X405X535MM	VD	
12007	2	CABINET - SINK OR ICE BIN - 24IN 610MM	VD	
12034	1	CABINET - VARIABLE TO 36IN 915MM	VD	
12043 12050	1	CABINET - POS - 29IN 735MM CABINET - POS BRIDGE FOR SAFE - 22X27IN 560X685MM	VD VD	
12067	1	CABINET - WARMING WITH TRASH DROP - 12IN 305MM	VD	
12080	4	CABINET - 15IN 380MM	VD	
12096	1	CABINET - WITH DRAWER - 15IN 380MM	VD	
12098	2	CABINET - BREW GRIND - 24IN 610MM	VD	
12786	1	CABINET - WITH TRASH DROP - 15IN 380MM	VD	
12236	1	CONDIMENT CART SINGLE TOP SOLID	VD	
12367	2	SURFACE MERCH FEATURE CUBE FREESTANDING TALL		NOT PROVIDED BY CASEWORK
12640	1	NEWSPAPER STAND 4 TIER - 39IN 990MM		VENDOR
13191	1	MERCH BAY UNIT END PANELS METAL MESH	SB	NOT PROVIDED BY CASEWORK VENDOR
13331	2	MERCH BAY UNIT	SB	NOT PROVIDED BY CASEWORK VENDOR
13374	1	CONDIMENT CART SINGLE BASE FRAME	SB	NOT PROVIDED BY CASEWORK VENDOR
13377	1	CONDIMENT CART SINGLE FINISH PANELS	VD	
13399	1	CONDIMENT CART SINGLE METAL TOP ASSEMBLY	SB	NOT PROVIDED BY CASEWORK VENDOR
COUNTERTO		COUNTEDTOD HAND ONLY OTAIN! EQQ. 45IN	\ /D	T
11915	1	COUNTERTOP - HAND SINK STAINLESS - 15IN 380MM	VD	
11931	1	COUNTERTOP - ESPRESSO RINSE SINK STAINLESS - LH - 126 OR 137IN 3200 OR 3480MM	VD	
12011	1	COUNTERTOP - POS SOLID SURFACE - 80IN 2030MM	VD	
12120	1	COUNTERTOP - HANDOFF SOLID SURFACE - LH - 30X35IN 760X890MM	VD	
12441	1	COUNTERTOP - ESPRESSO WING ICE BIN STAINLESS - LH	VD	
12443	1	COUNTERTOP - CBS SOLID SURFACE - LH - 100IN 2540MM	VD	
12780	1	COUNTERTOP - BREW GRIND RINSE SINK AND TRASH SOLID SURFACE - LH - 117IN 2970MM	VD	
13236	1	COUNTERTOP - SIDELINE SOLID SURFACE - VARIABLE TO 36IN 915MM	VD	
14294	1	COUNTERTOP - WARMING SOLID SURFACE - 72IN 1830MM	VD	
DIEWALL		1	1	1
11908	1	DIEWALL - HANDOFF SUPPORT - LH - 31X19IN 795X490MM	VD	
12465	1	DIEWALL - ESPRESSO - LH - 137IN 3480MM	VD	
12757 12758	1	DIEWALL - VARIABLE TO 96IN 2440MM DIEWALL - TOP CAP - VARIABLE TO 96IN	VD VD	
12803	1	2440MM DIEWALL - ESPRESSO TOP CAP - LH - 137IN	VD	
)TUED		3480MM		1
11155	2	ESPRESSO MACHINE PUMP MOUNT - 10X10IN 255X255MM	VD	
11885	1	POS CASH CORRAL DOUBLE - 40IN 1015MM	VD	
12100	4	ESPRESSO COUNTERTOP SUPPORT LEG	VD	
12449		STAINLESS ESPRESSO SNEEZE GUARD - 137IN 3480MM	VD	
12759	1 1	ESPRESSO SNEEZE GUARD - VARIABLE TO	VD	
12816	5	96IN 2440MM FRENCH CLEAT - VARIABLE TO 96IN 2440MM	VD	DESIGNER TO VERIFY QUANTITY. OVERALL LENGTH REQUIRED 28'-0"
PANEL		1	<u> </u>	OVERALL LENGTH REQUIRED 28'-0"
12028	2	PANEL - POS - 29IN 735MM	VD	
		PANEL - ESPRESSO - LH - 137IN 3480MM	VD	
12445				1
12473	1	PANEL - POS - 22IN 560MM	VD	
		PANEL - POS - 22IN 560MM PANEL - VARIABLE TO 96IN 2440MM	VD VD	

	CASE	NORK MCS CAB	INET BASE OPTION SCHEDULE
DESIGN ID	COUNT	BASE OPTION	DESCRIPTION
11945	2	Box Base	CABINET - 12IN 305MM
11972	1	Other	CABINET - ESPRESSO - 24IN 610MM
12007	2	Other	CABINET - SINK OR ICE BIN - 24IN 610MM
12034	1	Box Base	CABINET - VARIABLE TO 36IN 915MM
12043	2	Box Base	CABINET - POS - 29IN 735MM
12050	1	Box Base	CABINET - POS BRIDGE FOR SAFE - 22X27IN 560X685MM
12067	1	Box Base	CABINET - WARMING WITH TRASH DROP - 12IN 305MM
12080	4	Box Base	CABINET - 15IN 380MM
12096	1	Box Base	CABINET - WITH DRAWER - 15IN 380MM
12098	2	Box Base	CABINET - BREW GRIND - 24IN 610MM
12786	1	Box Base	CABINET - WITH TRASH DROP - 15IN 380MM

	CW FINISH - NCS	FINISH	
LOCATION	DESCRIPTION	CODE	COMMENTS
WALL BASE	WOOD - GREY RUSTIC	WD0052	T
CABINETS	WOOD - GRET RUSTIC	VVD0052	
	DI ACTIC I AMINIATE FAICEDOADD	DI 0040	
BACKBAR UPPER STORAGE CUBBIES	PLASTIC LAMINATE - FAKEBOARD - MOTTLED BLACK	PL0019	
UNDERCOUNTER CABINET EDGE BANDING	PLASTIC LAMINATE - BLACK		
UNDERCOUNTER CABINET EXPOSED BACK, SIDE	PLASTIC LAMINATE - BLACK		
UNDERCOUNTER CABINET EXTERIOR	PLASTIC LAMINATE - FAKEBOARD - MOTTLED BLACK	PL0019	
UNDERCOUNTER CABINET INTERIOR	PLASTIC LAMINATE - ALMOND (ST655-S)		
CAFE	/	<u> </u>	1
CHAIR RAIL	WOOD - GREY RUSTIC	WD0052	
CONDIMENT CART TOP	COMPOSITE - RAIN CLOUD	CP0002	
CONDIMENT CART, FOOD CASE WALL CLADDING	WOOD - GREY RUSTIC	WD0052	
COUNTERTOPS - BACKBAR			
BACKBAR, SIDELINE COUNTERTOPS	COMPOSITE - RAIN CLOUD	CP0002	
ESPRESSO COUNTERTOPS	COMPOSITE - RAIN CLOUD	CP0002	
HAND SINK COUNTERTOP	STAINLESS STEEL - #4 BRUSHED 16GA SST		
COUNTERTOPS - FRONT BAR			
HANDOFF PLANE	COMPOSITE - CEASER STONE - 6600 NOUGAT	CP0008	
POS, FRONTBAR COUNTERTOPS	COMPOSITE - CEASER STONE - 6600 NOUGAT	CP0008	
FINISH PANELS			1
ESPRESSO FINISH PANELS	WOOD - GREY RUSTIC	WD0052	
FINISH PANEL MOUNTING BRACKETS	COLD ROLLED STEEL	MT0002	
FINISH PANEL TRIM DETAILS	HOT ROLLED STEEL WITH MATTE SEALER	MT0011	
HANDOFF, SIDELINE FINISH PANELS	WOOD - GREY RUSTIC	WD0052	
POS, FRONTBAR FINISH PANELS	WOOD - GREY RUSTIC	WD0052	
OTHER		1	1
ESPRESSO TOP CAP	WOOD - CUSTOM STAINED TO MATCH DARK GREY OF WD0052		
OVER "BLACK" DUPLEX OUTLETS IN WAINSCOT LOCATIONS	SWITCHPLATE - PART #4752-112-CD VENETIAN BRONZE		GC SUPPLIED

<u> </u>		SPECIALTY EQUIPMENT SCHE		
DESIGN ID	COUNT	DESCRIPTION	RESP.	COMMENTS
COOLING				
10473	2	FRIDGE UNDERCOUNTER 2 DOOR - 48IN 1220MM	SB	
10967	1	FREEZER REACH IN 2 DOOR - 51IN 1295MM	SB	
11083	1	FRIDGE REACH IN 2 DOOR - 51X35IN 1295X890MM	SB	
12618	1	FRIDGE UNDERCOUNTER 1 DOOR WITH SHELF - 27IN 685MM	SB	
EQUIPMENT	-			
10312	2	BREWER SINGLE SOFT HEAT WARMING STAND	SB	
10724	1	GRINDER GRINDMASTER	SB	
10746	1	BREWER DUAL SOFT HEAT	SB	
10856	4	BREWER SERVER SOFT HEAT	SB	
11070	1	DISHWASHER SANITIZER	SB	
12407	2	OVEN TURBOCHEF NEXT GENERATION	SB	
12508	2	BLENDER QUIET MODEL ON COUNTER	SB	
12694	2	ESPRESSO MACHINE MASTRENA	SB	
OOD CASE				
10797	1	FOOD CASE - STACKED - 66IN 1675MM - BRONZE	SB	
CE				
10344	1	ICE - BIN DROP IN 90LB 40KG	SB	
10527	1	ICE - BIN DROP IN 45LB	SB	
10648	1	ICE - MACHINE 1462LB AIR COOLED SIDE VENT	SB	
10880	1	ICE - BIN 1000LB	SB	
OTHER				
10091	1	CUP DISPENSER TALL HOT VERTICAL	SB	
10099	2	RESTROOM TOILET PAPER HOLDER	SB	
10172	2	RESTROOM SEAT COVER DISPENSER	SB	
10305	1	TRASH DROP RING LINER SQUARE - BLACK	SB	
10314	1	SCALE DIGITAL WITH ADJUSTABLE DISPLAY MOUNT	SB	
10384	2	DIAPER CHANGING STATION HORIZONTAL	SB	
10396	1	CUP DISPENSER SHORT HOT VERTICAL	SB	
10467	1	FILE CABINET 2 DRAWER	SB	
10501	1	FIRE EXTINGUISHER	SB	
10769	2	RESTROOM GRAB BAR VERTICAL - 18IN 455MM	SB	
10791	2	CUP DISPENSER GRANDE VENTI COLD VERTICAL	SB	
10855	2	CUP DISPENSER GRANDE VENTI HOT VERTICAL	SB	
10858	1	CUP DISPENSER TALL COLD VERTICAL	SB	
10862	4	RESTROOM GRAB BAR - 36IN 915MM	SB	

SPECIALTY EQUIPMENT SCHEDULE - "E"						
DESIGN ID	COUNT	DESCRIPTION	RESP.	COMMENTS		
10947	1	SOAP DISPENSER WALL MOUNTED	SB			
10977	4	PAPER TOWEL DISPENSER FULL SIZE - TRANSLUCENT GRAY	SB			
11115	3	SOAP DISPENSER SINK MOUNTED	SB			
13330	1	MOBILE CUP DISPENSER CADDY	SB			
13584	1	CUP DISPENSER TRENTA COLD VERTICAL	SB			
STORAGE						
10176	1	ROLLING PASTRY TRAY RACK	SB			
10222	1	WIRE SHELF GRID AT SINK	SB			
10293	1	10 COMP LOCKER	SB			
10416	5	WORKROOM WIRE SHELVING	SB			
10462	5	WORKROOM WIRE SHELVING POSTS	SB			
10698	1	MOP RACK WITH 3 HOLDERS				
10838	1	ROLLING WIRE CART FOR 3 COMP SINK	SB			
11104	1	10 COMP LOCKER BASE	SB			
13578	1	DISHWARE DRYING RACK - 21IN 535MM	SB			
13834	1	BASE - 24X18IN 610X455MM				

DESIGN ID	COUNT	FURNITURE SCHEDULE DESCRIPTION	RESP.	COMMENTS
BANQUETTE		DESCRIPTION	RESP.	COMMENTS
X12334	4	BANQUETTE	VD	CUSTOM 54 IN WD0052 - F0015
CHAIR		DANQUETTE	IAD	COSTON 54 IN WD0052 - F0015
12146	20	CHAIR - CAFE SLATTED METAL SUITE WITH	SB	
-		ARMS - BLACK MT0028		
12330	4	CHAIR - LOUNGE BARREL BACK - BRICK RED NATURAL F0017	SB	
12373	3	CHAIR - LOUNGE ARMLESS BASKET WEAVE - TAUPE WOVEN F0044	SB	
12706	2	CHAIR - LOUNGE BASKET WEAVE SECTIONAL CORNER - TAUPE WOVEN F0044	SB	
12708	5	CHAIR - LOUNGE BASKET WEAVE CUSHION FILLER - TAUPE WOVEN F0044	SB	
13357	14	CHAIR - CAFE PADDLE BACK - DISTRESSED DARK WARM BROWN WD0001	SB	
13369	10	CHAIR - STOOL 29IN 735MM INDUSTRIAL UPHOLSTERED - ANTIQUE PEWTER AND BRICK RED NATURAL MT0034 F0017	SB	
DESK			1	
10123	1	DESK - MANAGERS WORKSTATION - 60X30X30IN 1525X760X760MM - ALMOND LAMINATE	SB	
10605	1	DESK - MANAGERS WORKSTATION KEYBOARD TRAY - BLACK PLASTIC	SB	
10809	1	DESK - MANAGERS WORKSTATION SHELVES WALL MOUNTED - ALMOND LAMINATE	SB	
MIRROR				
10093	2	MIRROR - RESTROOM - 18X30IN 455X760MM	SB	
TABLE				
10513	8	TABLE - CAFE METAL SUITE ROUND - 28IN 710MM - BLACK MT0028	SB	
11078	4	TABLE - CAFE BASE UNIVERSAL - 18X28IN 455X710MM - BLACK WRINKLE POWDERCOAT	SB	
12160	2	TABLE - ACCESSIBLE METAL SUITE - 39X23IN 990X585MM - BLACK MT0028	VD-SYNSO R	CUSTOM ADA BASE W/ CP0002 TC
12212	5	TABLE - BASE BAR HEIGHT DOME ACCENT - 18X42IN 455X1065MM - HOT ROLLED STEEL MT0011	SB	
12379	2	Table - Occasional Steel with X Base Square - Aged Dark Brown CM0001	SB	
12707	3	TABLE - OCCASIONAL BASKET WEAVE SQUARE - BLACK WEAVE F0045	SB	
X0001	1	CUSTOM COMMUNITY TABLE TOP	VD	CUSTOM WD0035 - 120"x30"
x0105	9	Table - Top Square - 24in	VD	CP0002
X0107	1	ADA TABLE TOP - 38X24IN 965X610MM - \	VD	CUSTOM CP0002 - 38"x24"
X0108	1	METAL STRAP BASE	VD	
X1967	3	TBIBSH 40 NATURAL STEEL W/ CLEAR COAT	VD WINDFALL	
x12271	1	TABLE - BASE COMMUNITY I BEAM - TBIB27 - PR NATURAL STEEL W/ CLEAR COAT	VD WINDFALL	

		GRAPHICS SCHEDULE -	"G"	
DESIGN ID	COUNT	DESCRIPTION	RESP.	COMMENTS
GRAPHICS				
X0010	1	FRAMED ART IMAGE SIZE: 30" x 42"	VD	
X0011	1	FRAMED ART IMAGE SIZE: 30" x 42"	VD	
X0012	1	FRAMED ART IMAGE SIZE: 30" x 42"	VD	
X0013	1	FRAMED ART IMAGE SIZE: 30" x 42"	VD	
X0014	1	FRAMED ART IMAGE SIZE: 30" x 42"	VD	
X0015	1	FRAMED ART IMAGE SIZE: 30" x 42"	VD	
X0016	1	FRAMED ART IMAGE SIZE: 30" x 42"	VD	
X0017	1	30" x 42" H.R.S. PLATE	VD	
X0018	1	30" x 42" H.R.S. PLATE	VD	
X0019	1	30" x 42" H.R.S. PLATE	VD	
X0020	1	30" x 42" H.R.S. PLATE	VD	
X0021	1	30" x 42" H.R.S. PLATE	VD	
X0022	1	FRAMED ART IMAGE SIZE: 30" x 42"	VD	
X0023	1	FRAMED ART IMAGE SIZE: 30" x 42"	VD	
X0024	1	FRAMED ART IMAGE SIZE: 30" x 42"	VD	
X0025	1	FRAMED ART IMAGE SIZE: 30" x 42"	VD	
X0026	1	FRAMED ART IMAGE SIZE: 30" x 42"	VD	
GRAPHICS -	- INTERIOR	MENU		
12837	5	MENU BOARD - 1 FRONT PANEL INSERT STYLE	VD	
12838	1	MENU BOARD - DAILY OFFERING CHALKBOARD FRONT PANEL RECTANGULAR	VD	
12839	6	MENU BOARD - UNIVERSAL MOUNTING HARDWARE FOR FRONT PANELS	VD	
GRAPHICS -	- OTHER		-	
10579	2	RESTROOM SIGN SET ACCESSIBLE CALIFORNIA	SB	
10753	2	RESTROOM SIGN SET ACCESSIBLE	SB	



Starbucks Coffee

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Revision Schedule

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Store #: Project #: 55066-003

Concept: Issue Date:

Design Manager: LEED® AP:

Production Designer:

SCHEDULES

A. HUMAYDEN

Sheet Number:

		WALL TREATMENT (AREA)	SCHEDULE - "Q'	CHEDULE - "Q"	
DESIGN ID	AREA	DESCRIPTION	RESP.	COMMENTS	
Ceramic	•				
12433	947 SF	Tile - Cream Mosaic - 6x24in 150x610mm	SB	GROUT: LATCICRETE 60 - DUSTY GRAY	
12615	444 SF	Tile - Glossy Navy Blue - 2x8in 50x205mm	VD-PRATT & LARSON	GROUT: LATCICRETE 60 - DUSTY GRAY	
PLASTIC					
11469	1631 SF	FRP - WHITE	VD		

		WALL TREATMENT (LENGTH) SCHEDULE- "R"		
DESIGN ID	LENGTH	DESCRIPTION	RESP.	COMMENTS
x0004	0"	WALL - END CAP - HOT ROLLED STEEL MT0011		
CHAIR RAIL				
12173	73' - 2"	CHAIR RAIL - 4IN 100MM AT 36IN 915MM AFF H.R.S.	GC	SEE CASEWORK FINISH SCHEDULE FOR MATERIAL
WAINSCOT				
13098	72' - 11 1/4"	VINYL - WAINSCOT - LIGHT GREY AT 36IN 915MM AFF	VD	FLAT BAR DETAIL TO BE SUPPLIED BY GENERAL CONTRACTOR

		SIGNAGE SCHEDULE -	"S"	
DESIGN ID	COUNT	DESCRIPTION	RESP.	COMMENTS
SIGNAGE - I	DISK			
13164	3	SIGN - DISK SF ILLUMINATED FLUSH MOUNTED EVOLVED - 60IN 1525MM	SB	
SIGNAGE - V	VORDMARI	ζ		
11570	1	SIGN - STACKED ILLUMINATED FLUSH MOUNTED - 12IN 305MM	SB	

		FLOOR TREATMENT S	CHEDULE - "T"	
DESIGN ID	AREA	DESCRIPTION	RESP.	COMMENTS
CARPET	•			
X9005	38 SF	WALK OFF MAT - AZO 200 BERBER - CHARCOAL	VD PACIFIC MAT	
TILE	•			
11457	301 SF	TILE - WORKROOM	VD	LOCALLY SOURCED
12305	1424 SF	TILE - 12 X 24 LIGHT OLIVE GREY	SB	GROUT: LATCICRETE 60 - DUSTY GRAY

		WALL BASE SCHEDULE	- "B"	
DESIGN ID	LENGTH	DESCRIPTION	RESP.	COMMENTS
TILE BASE	•			
11434	75' - 2 3/4"	TILE BASE - WORKROOM	SB	LOCALLY SOURCED
X9001	130' - 11 1/2"	TILE BASE - STONE PEAK - 6X12IN 150X305MM COVE BASE - CLOUD SKY - USG612C109	VD	GROUT: LATICRETE 60 DUSTY GREY GC TO ORDER OUTSIDE CORNER (USG106C109_ AND INSIDE CORNER (USG161C109) AS NECESSARY
WOOD BAS	E			
11448	99' - 1 3/4"	H.R.S. BASE - GENERAL	GC	LOCALLY SOURCED

		LIGHTING F	IXTURE SC	HEDULE - "L"	
DESIGN ID	COUNT	DESCRIPTION	RESP.	BULB	COMMENTS
X0024	1	CUSTOM LIGHT FIXTURE SUPPORT	GC		
X07001	2	VINTAGE BARN ANGLED SHADE SCONCE		ITEM # 68360103 BULB 40W	Item# 68050128WZINC
EXIT			•		
11517	2	EMERGENCY EXIT LIGHT - BLACK		LED 5W LOW ENERGY OR EQUAL	
LAMP			•		
12906	12	LED PAR 20 1-9W NFL - WHITE			
RECESSED	CAN	1	1	1	1
13401	40	CAN - RECESSED TRIM BAFFLE - 5IN 125MM - BLACK			
13714	8	CAN - RECESSED TRIM WALL WASH - 5IN 125MM - BLACK			
13827	48	CAN - RECESSED INTEGRATED LED HOUSING - 5IN 125MM - 900LM NEW CEILING			
SCONCE					
11879	2	SCONCE - RESTROOM VANITY BOWED - SATIN NICKEL		(1) 12866 - FL T5 10-19W 22IN (550MM)	
X07002	3	GLASS FUNNEL FILAMENT SCONCE		ITEM# 68260003 BULB	Item# 68450068 VSTL
STRIP			1		
12552	13	TASK LIGHT INTEGRATED LED - 22IN 560MM - BLACK		(6) INTEGRAL LED 1W	JUMPER CORD REQUIRED WHEN CONNECTING MULTIPLE UNITS
TRACK					
12944	1	TRACK - WITH CONNECTORS - 16FT 488CM - WHITE			
12956	12	TRACK - FIXTURE OPEN FLARED - 3.5IN 90MM - WHITE		(1) 12906 - LED PAR 20 1-9W NARROW FLOOD	
TROFFER		·	•		•
11404	3	TROFFER - RECESSED - 48X24IN 1220X610MM - WHITE		(3) 12890 - FL T8 20-29W	

		SITE SCHEDULE - "	Y"		
DESIGN ID	COUNT	DESCRIPTION	RESP.	BULB	COMMENTS
OTHER			•		
10041	1	TRASH ROUND - 18IN 455MM			
10042	2	BIKE RACK HOOP			
UMBRELLA					
10065	5	UMBRELLA - 6FT 183CM - GREEN CANVAS WITH STARBUCKS WORDMARK F0056			
12147	5	UMBRELLA - BASE FOR CANOPY - BLACK MT0028			

RAILING SCHEDULE- "Z"				
DESIGN ID	LENGTH	DESCRIPTION	RESP.	COMMENTS
X0100	131' - 3 1/4"		GC	EXTERIOR METAL RAIL



Starbucks Coffee

2401 Utah Avenue South Seattle, Washington 98134 (206) 318-1575

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Architect of Record



Revision Schedule			
Rev	Date	Ву	Description

Store #: Project #: 55066-003

Concept:

Design Manager: LEED® AP:

Production Designer:

A. HUMAYDEN

SCHEDULES

Sheet Number: